PROPOSED TWO STOREY DWELLING WITH BASEMENT, POOL & SECONDARY DWELLING **AT 45 HILLCREST AVENUE, GREENACRE**

	DRAWING LIST					
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A00	COVER SHEET					
A01.01	DEMOLITION PLAN					
A01.02	SITE PLAN & ROOF PLAN, SITE ANALYSIS PLAN					
A01.03	WASTE MANAGEMENT PLAN AND SEDIMENT & EROSION CONTROL PLAN					
A01.04	LANDSCAPING PLAN					
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A08.02	3D MODEL CABANA					
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A10	3D_BASEMENT FLOOR					
A11	3D_GROUND FLOOR					
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A13	3D_MODEL					
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A18.01	SHADOW DIAGRAM - 21ST JUN					
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A18.04	3 HOURS OF SUNLIGHT TO LIVING - 21ST JUN					
A18.05	3 HOURS OF SUNLIGHT TO 50% POS - 20TH MAR					
A18.06	3 HOURS OF SUNLIGHT TO NEIGHBOURING LIVING - 21ST JUN					



ALL STANDARDS AND CODES INCLUDING BUT NOT LIMITED TO THE BCA/ NCC AND ANY REFERENCED AS/NZS STANDARD TO APPLY AND BE CONFORMED WITH AS REQUIRED.

- ALL DEMOLITION WORK IS TO BE CARRIED OUT IN ACCORDANCE WITH AS 2601 - 2001 (THE DEMOLITION OF STRUCTURES)

- CONVENTIONAL TIMBER ROOF FRAMING TO COMPLY WITH AS 1684.4-2006 TIMBER FRAMING CODE - COMPLY WITH PART 3.4.3 OF BCA - WALL CLADDING 3.5.3

- STEEL ROOF TO BE INSTALLED WITH A THERMAL BREAK WITH R-VALUE OF NOT LESS THAN 0.2 IN ACCORDANCE WITH NSW 13.2.3. (1)(2) OF BCA 2022

- METAL FRAME EXTERNAL WALLS TO BE INSTALLED WITH A THERMAL BREAK WITH AN R-VALUE OF NOT LESS THAN 0.2 IN ACCORDANCE WITH NSW 13.2.5(1)(2)

- STEEL STRUCTURES TO AS 4100

- RESIDENTIAL SLABS AND FOOTINGS TO AS 2870

- DAMP PROOF COURSE AND FLASHINGS TO AS 2904

- ALL GLAZING TO BE IN ACCORDANCE WITH H1 D8 OF BCA 2022

-SKYLIGHTS, EXTERNAL WINDOWS AND DOORS, EXHAUST FANS, CONSTRUCTION OF CEILINGS, WALLS AND FLOORS, EVAPORATIVE COOLERS TO BE SEALED IN ACCORDANCE WITH PART 13.4.(2)(3)(4)(5)(6)(7) OF BCA 2022. - INSULATION MUST COMPLY WITH AS/NZS 4859.1 AND TO BE INSTALLED IN ACCORDANCE WITH PART 13.2.2(1)(2)(3) OF BCA 2022

- INSULATION OF SERVICES, CENTRAL HEATING WATER PIPING, HEATING AND COOLING DUCTWORK TO BE COMPLETED IN ACCORDANCE WITH PART 13.7(2)(3)(4) OF BCA 2022.

- HARD WIRED SMOKE ALARM TO BE INSTALLED IN ACCORDANCE WITH PART NSW 9.5.1 OF NCC 2022 - WATERPROOFING TO WET AREAS AND BATHROOM CONSTRUCTION TO BE IN ACCORDANCE WITH AS 3740-1994 WATERPROOFING OF WET AREAS WITH IN RESIDENTIAL BUILDINGS + PART

2.1, PART3.8.1 OF BCA

- TREATMENT FOR THE PROTECTION OF THE BUILDING FROM SUBTERRANEAN TERMITES SHALL BE CARRIED OUT IN ACCORDANCE WITH AS 3660.1. IN SELECTING APPROPRIATE MATERIAL + COMPLY WITH PART 3.1.3 OF THE BCA. - SUB FLOOR VENTILATION UNDER SUSPENDED FLOORS MUST BE IN ACCORDANCE WITH PART 3.4.1 OF THE BCA. - NON-SLIP NOSING'S OR TREADS TO STAIRS TO COMPLY WITH CLAUSE 3.9.1.4 OF THE BCA - ALL MASONRY WALLS TO HAVE EXPANSION JOINTS TO COMPLY WITH BCA REQUIREMENTS - FIRE RATED MASONRY WALL WITH AN FRL OF 60/60/60 AS PER PART 9.2.3 OF NCC 2022 - A HIGH IMPACT VAPOR BARRIER TO COMPLY AS PER THE REQUIREMENTS OF CLAUSE 3.2.2.6 OF THE BCA

- MASONRY CONSTRUCTION TO COMPLY WITH AS 3700
- GUTTERS AND DOWNPIPES TO COMPLY WITH AS 3500.3 OR 3500.5 - ALL ENCLOSED WATER CLOSET DOORS ARE TO SWING OUT OR TO BE PROVIDED WITH LIFT OFF HINGES OR THE LIKE IF THE DOOR IS WITHIN 1200MM OF THE PAN IN ACCORDANCE WITH THE REQUIREMENTS OF CLAUSE 3.8.3.3 OF VOLUME 2 OF THE NCCS (BCA)

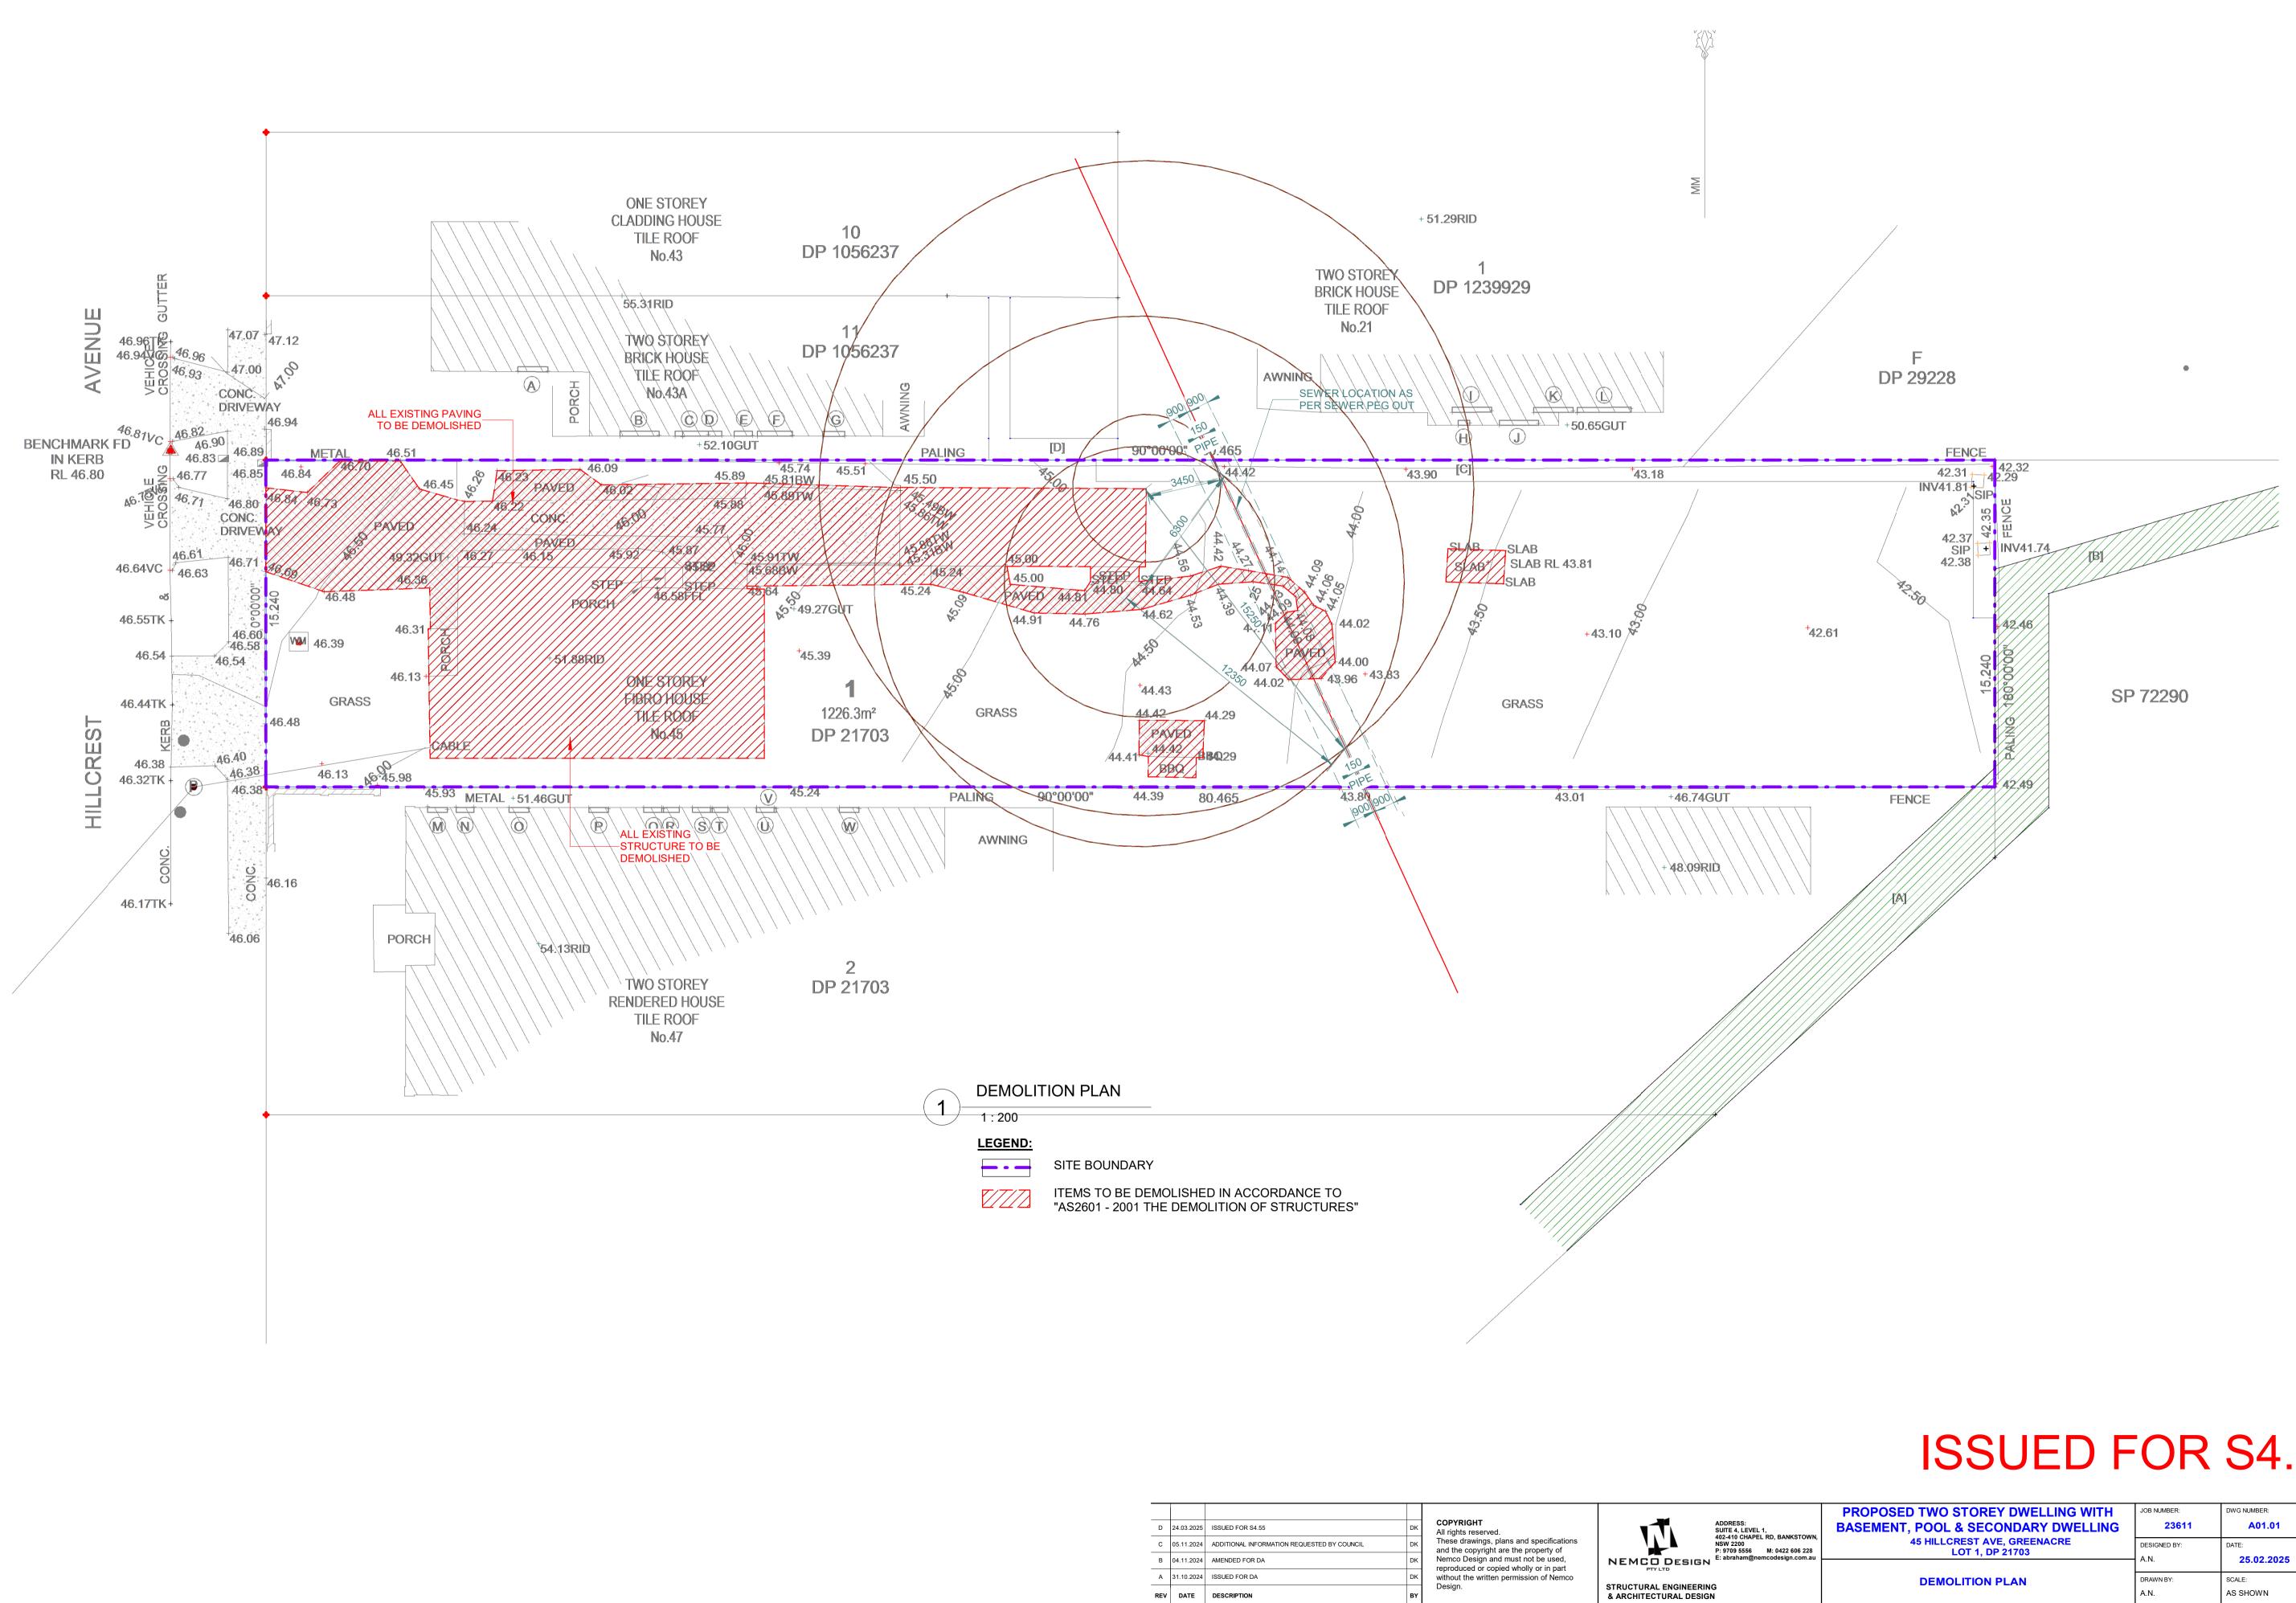
- ALL STAIRS WILL BE CONSTRUCTED IN ACCORDANCE WITH THE REQUIREMENTS OF CLAUSE 3.9.1.2 OF VOLUME 2 OF THE NCCS-BCA

- THE FINISH OF ALL OF THE STAIRS WILL MEET THE REQUIREMENTS OF CLAUSE 3.9.1.4 OF VOLUME 2 OF THE NCCS-BCA - ALL LANDINGS PROVIDED WILL MEET THE REQUIREMENTS OF CLAUSE 3.9.1.5 OF VOLUME 2 OF THE NCCS-BCA
- PAINTING TO AS 2311
- HOUSING WIND LOADINGS AS 4055

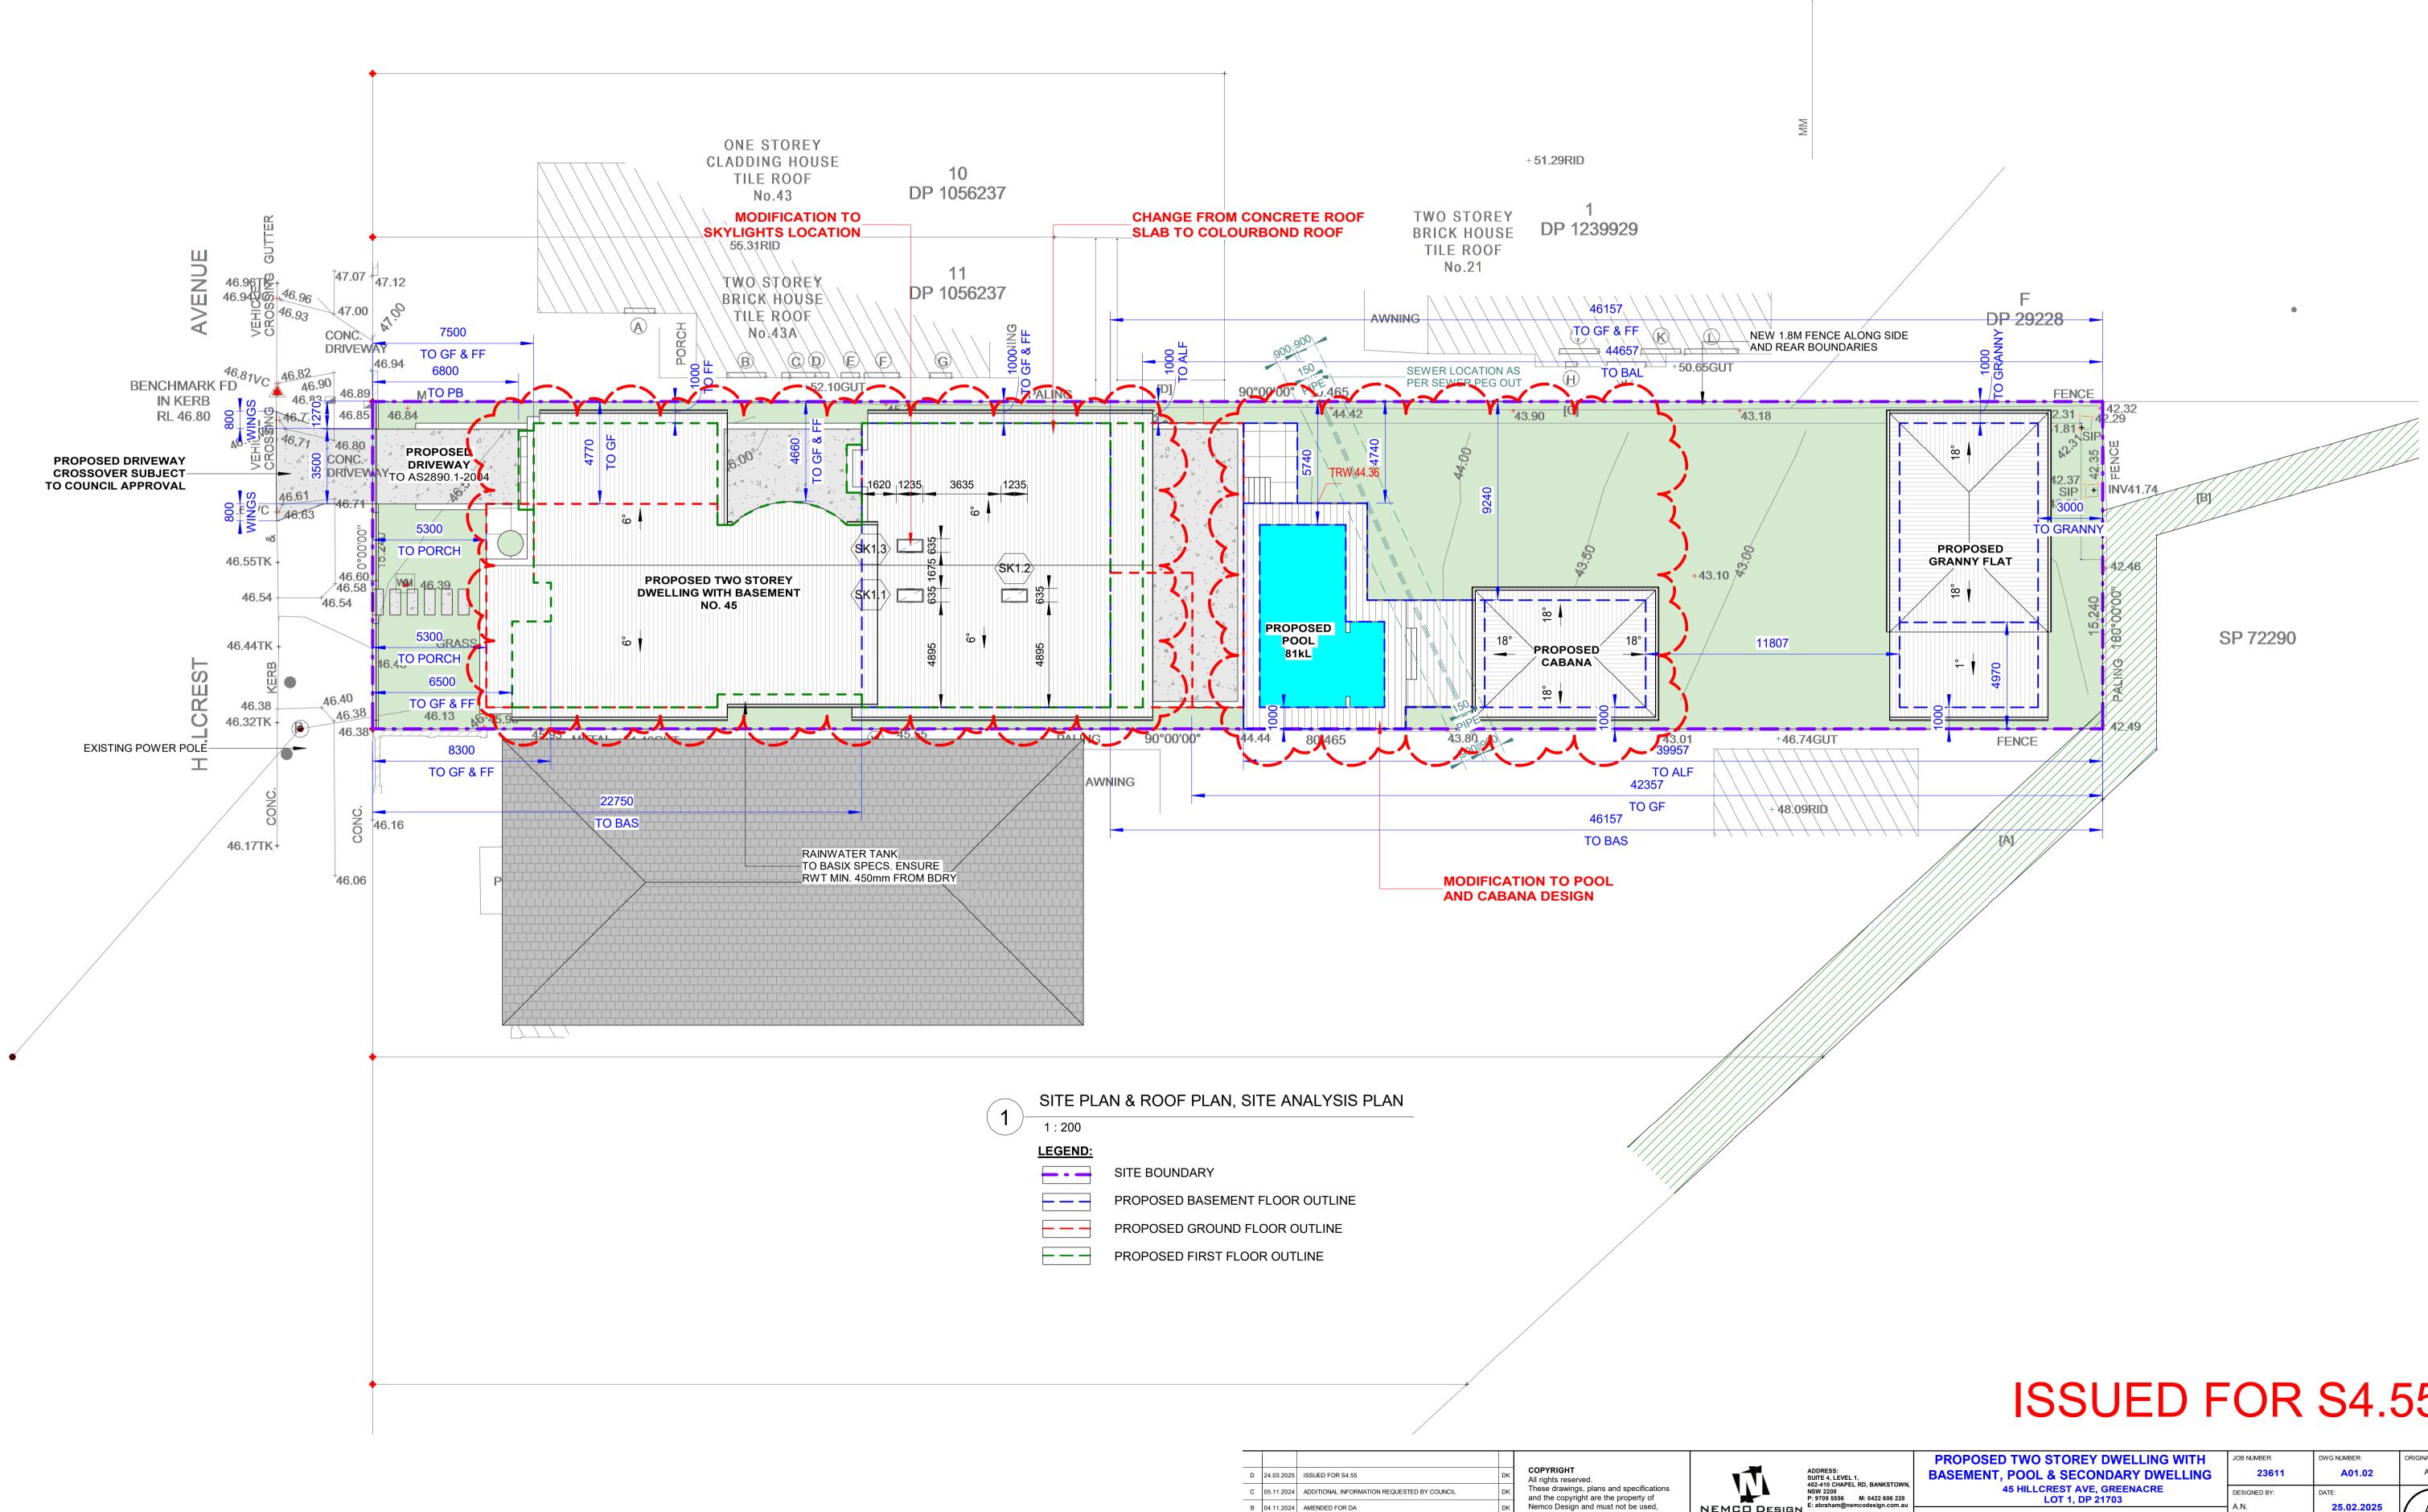
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- MECHANICAL VENTILATION TO BE PROVIDED AS PER BCA PART 10.6.3, 10.8.2 & 10.8.5 SUED FOR S4.55

. BANKSTOWN.	PROPOSED TWO STOREY DWELLING WITH BASEMENT, POOL & SECONDARY DWELLING	JOB NUMBER: 23611	DWG NUMBER:	ORIGINAL SIZE: A2
, BANKSTOWN, 0422 606 228 design.com.au	45 HILLCREST AVE, GREENACRE LOT 1, DP 21703	DESIGNED BY: A.N.	DATE: 25.02.2025	
	COVER SHEET	DRAWN BY: A.N.	SCALE: AS SHOWN	



STOWN.	PROPOSED TWO STOREY DWELLING WITH BASEMENT, POOL & SECONDARY DWELLING	JOB NUMBER: 23611	DWG NUMBER: A01.01	ORIGINAL SIZE: A2
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		DRAWN BY:	SCALE:	
	DEMOLITION PLAN	A.N.	AS SHOWN	\searrow



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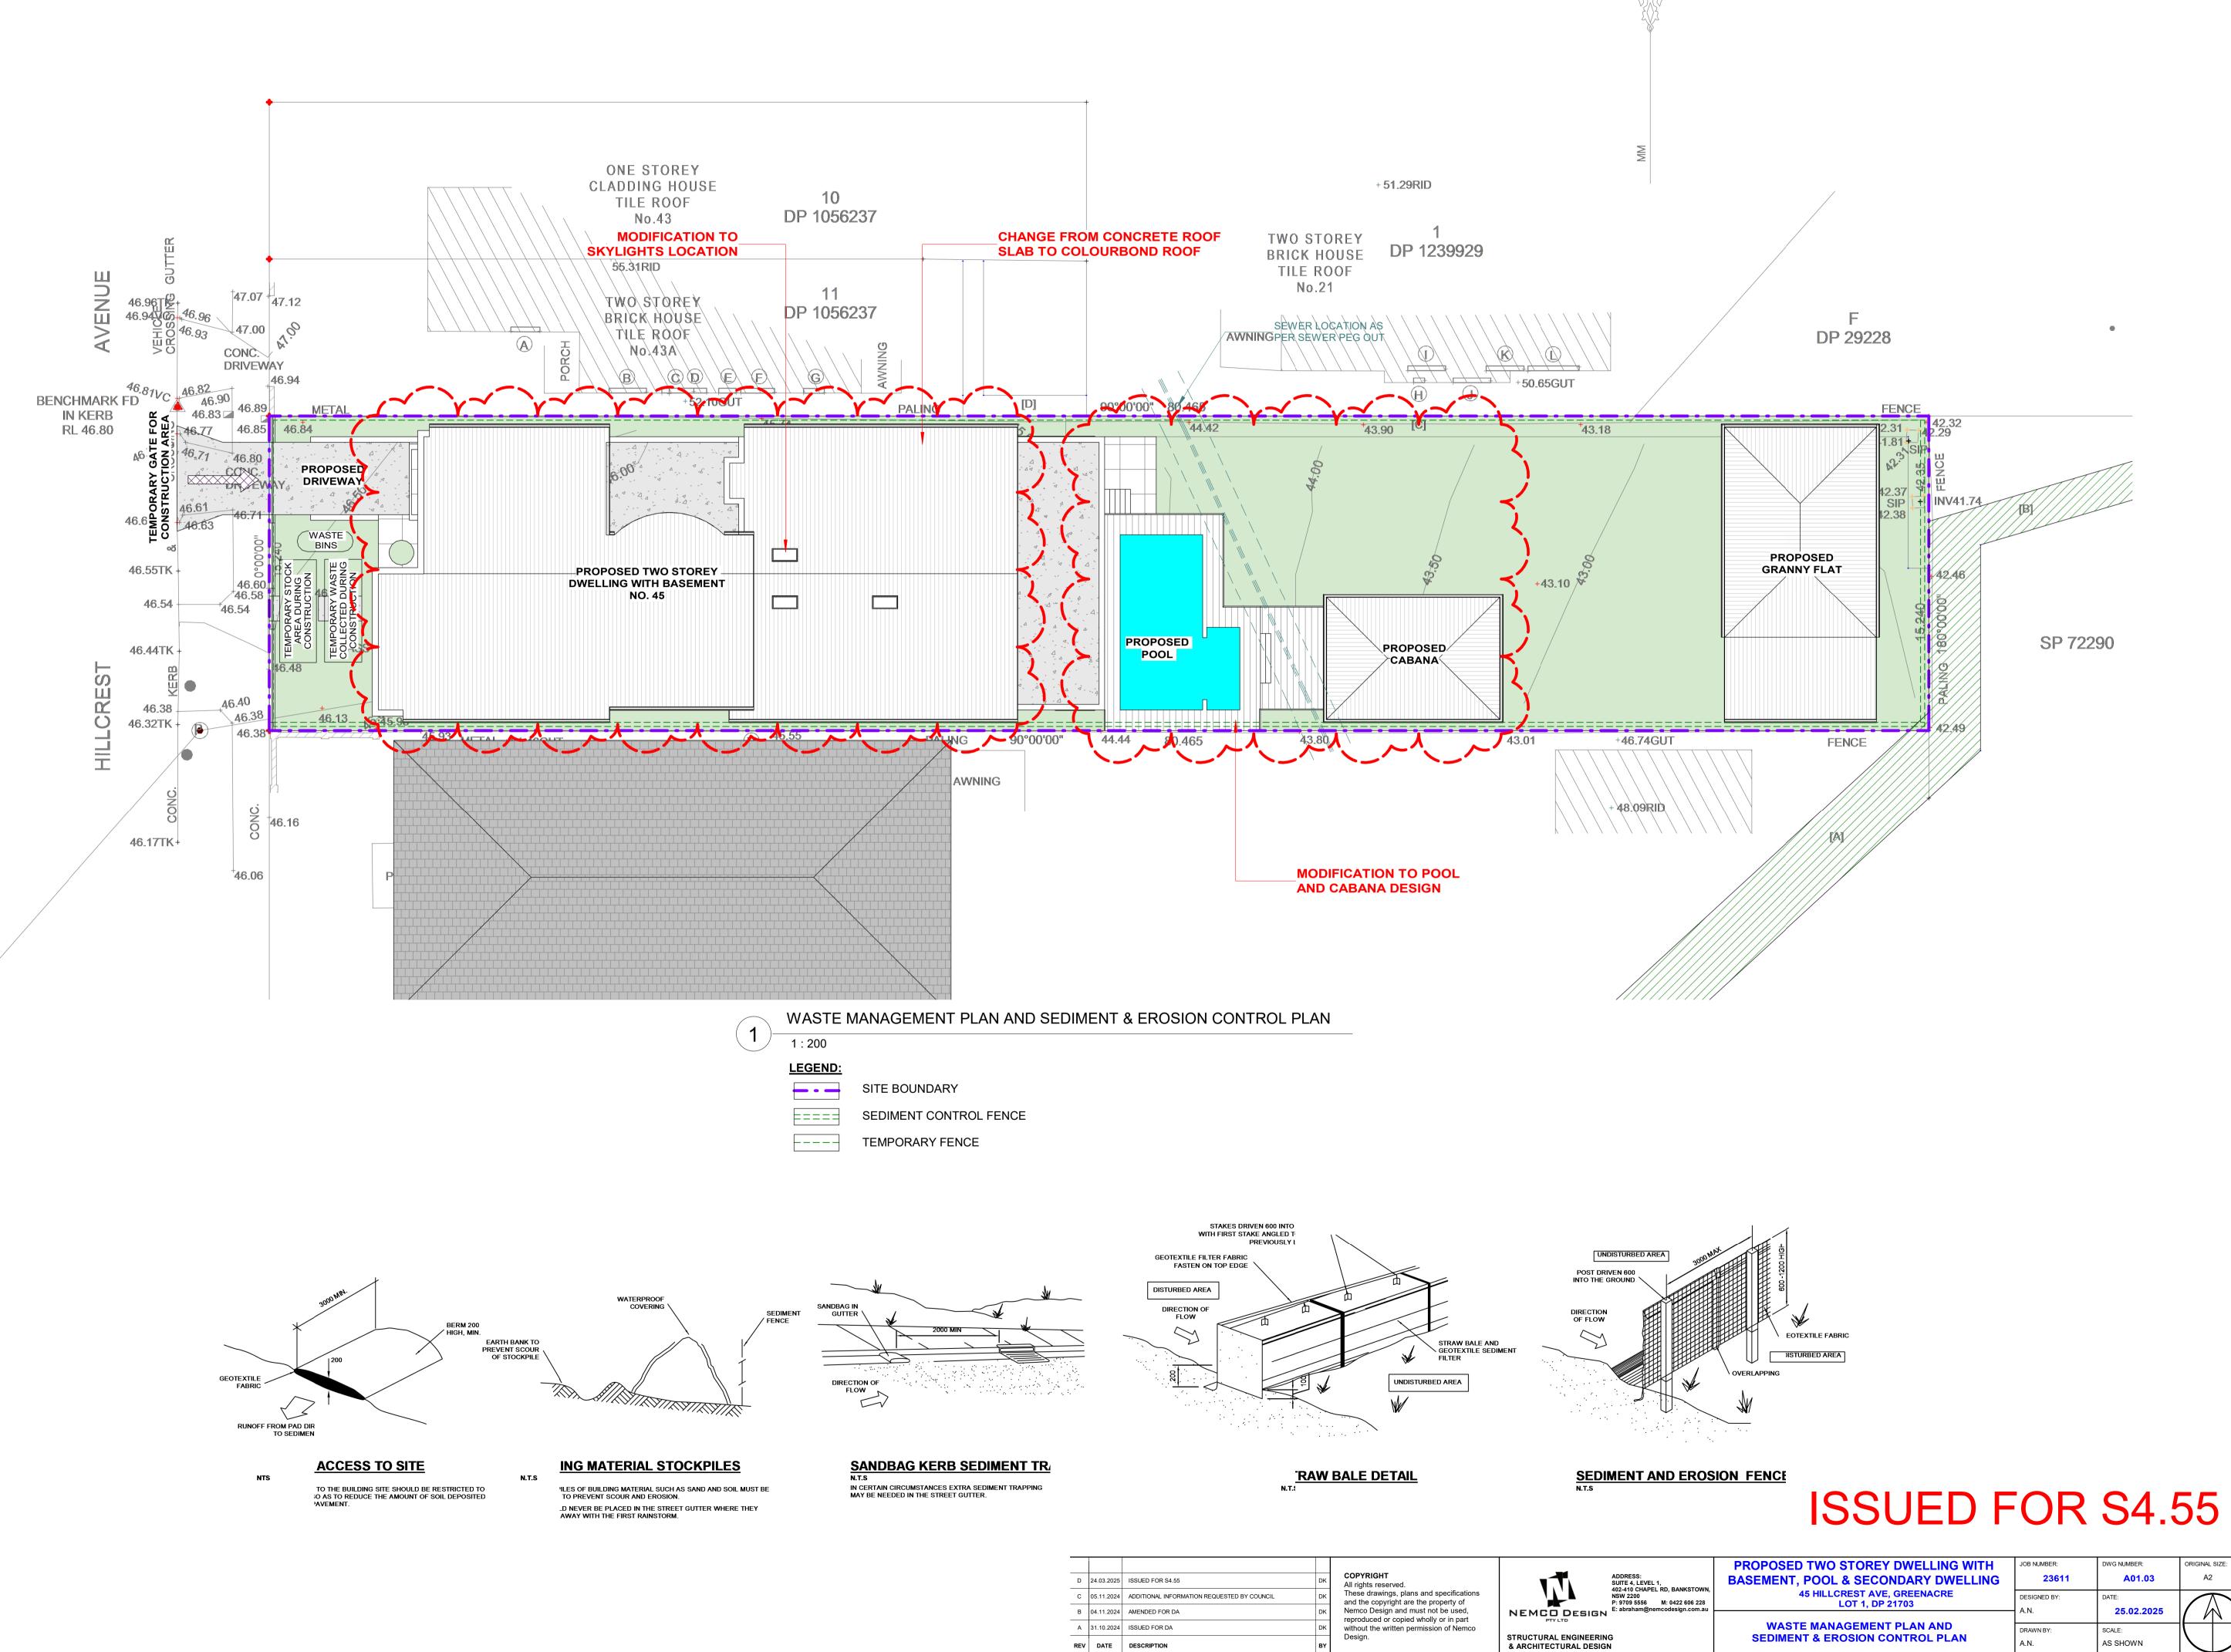
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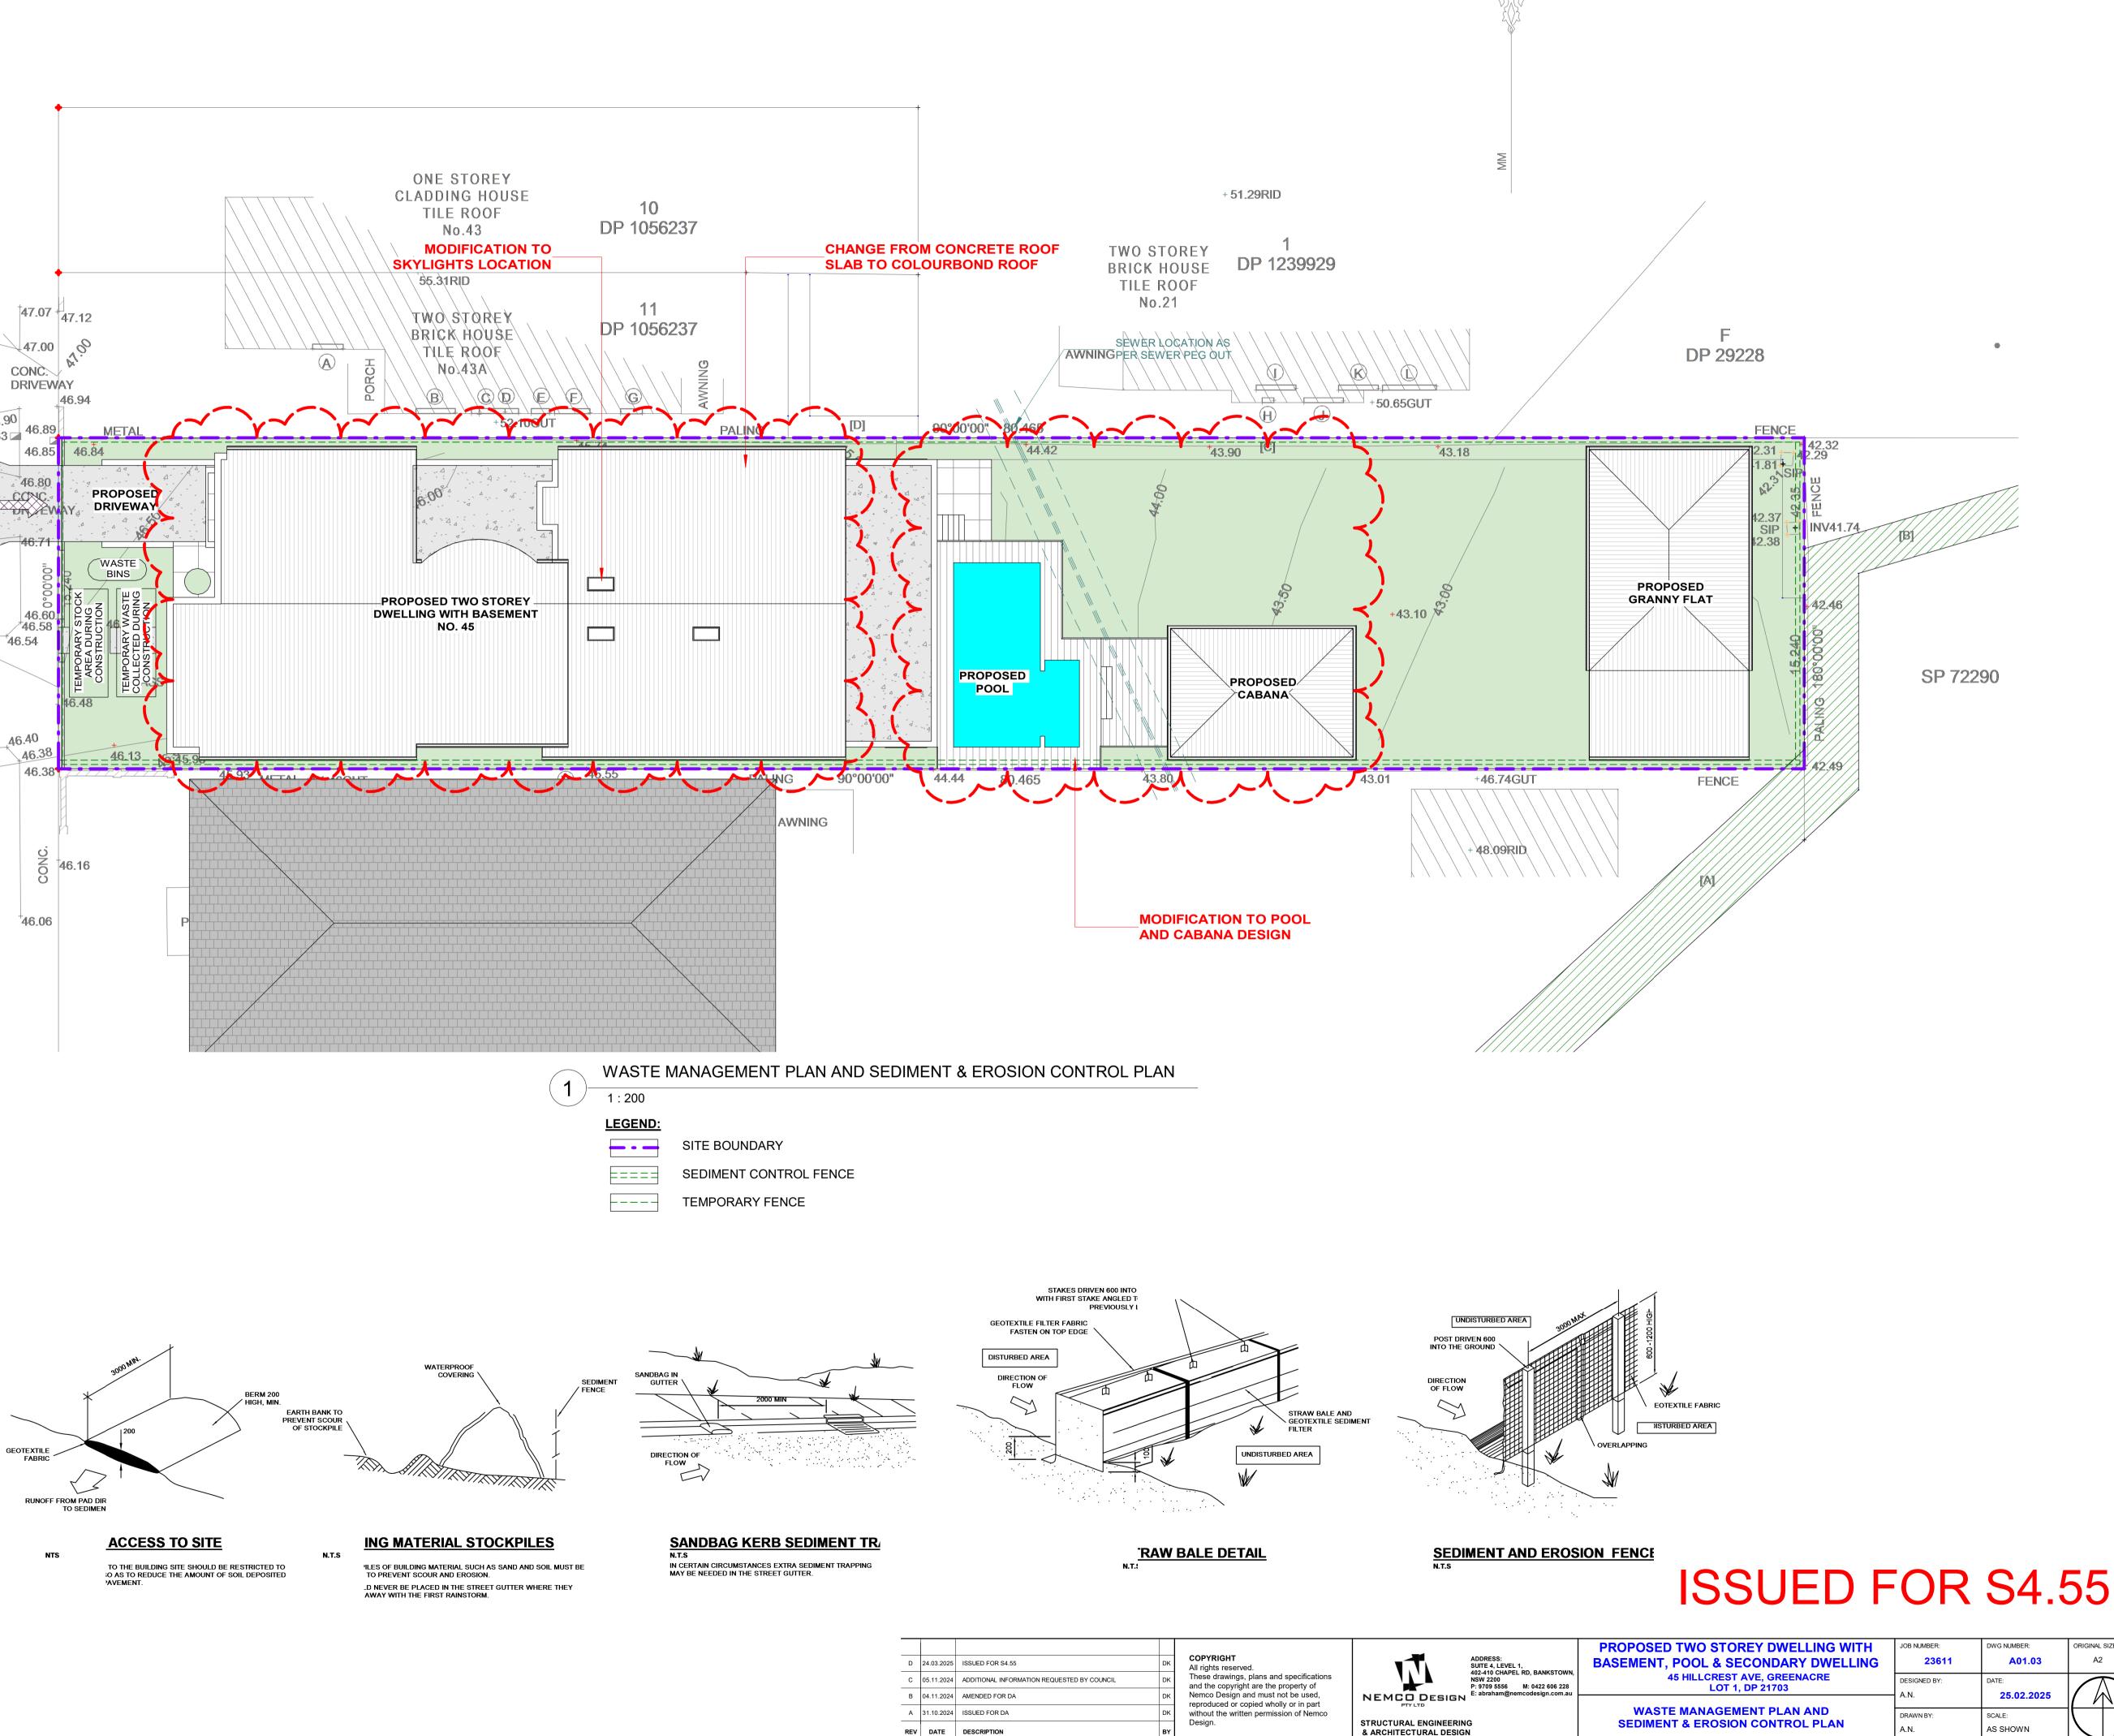
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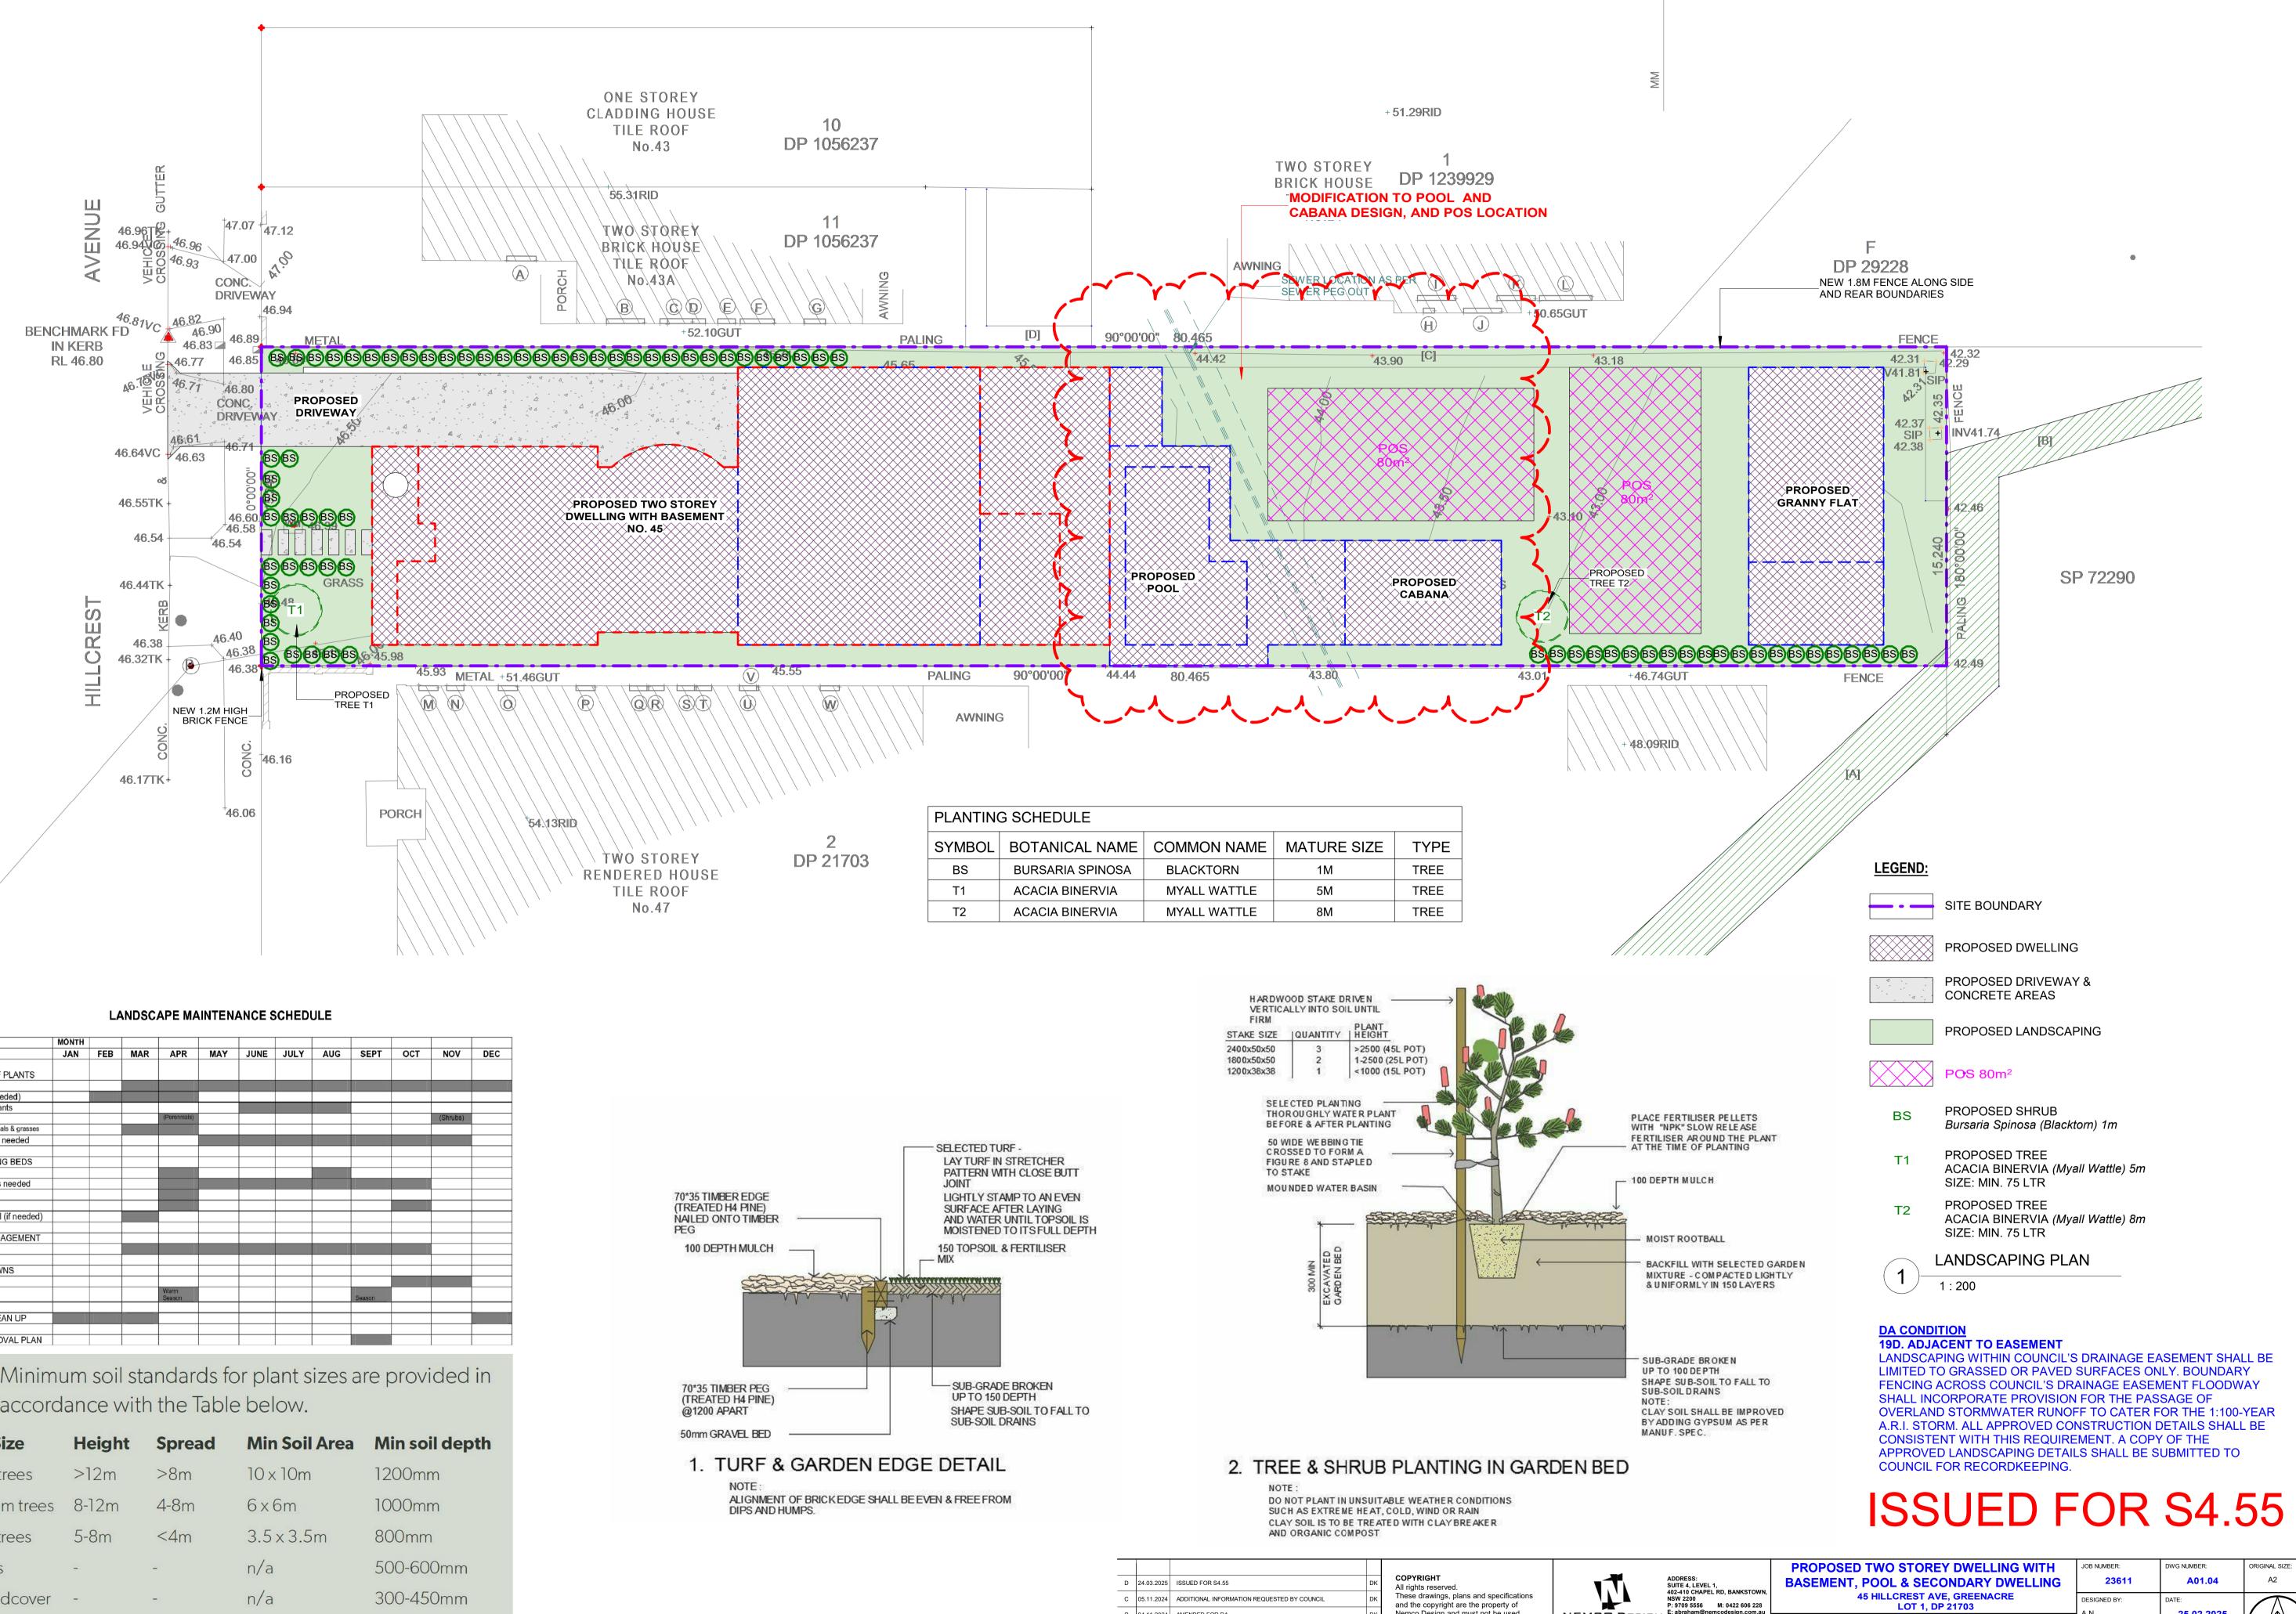
Design.

E: abraham@

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06 228 .com.au	45 HILLCREST AVE, GREENACRE LOT 1, DP 21703	DESIGNED BY: A.N.	DATE: 25.02.2025	
oomuu	SITE PLAN & ROOF PLAN, SITE ANALYSIS		20.02.2020	
	SHE PLAN & ROOF PLAN, SHE ANALTSIS PLAN	DRAWN BY:	SCALE:	
	FLAN	A.N.	AS SHOWN	$ \setminus / $







Task	MONTH											
	JAN	FEB	MAR	APR	MAY	JUNE	JULY	AUG	SEPT	ОСТ	NOV	DEC
CARE OF PLANTS												
Monitoring												
Pruning (if needed)												
Deadhead plants												
Fertilization				(Perennials)							(Shrubs)	
Cut back perennials & grasses												
Watering - as needed												
PLANTING BEDS												
Edging												
Weeding – as needed												
Mulching												
Soil testing												
Leaf Removal (if needed)												
PEST MANAGEMENT												
Monitoring												
LAWNS												
Fertilize/Lime												
Seeding				Warm Season					Season			
WINTER CLEAN UP												
												
SNOW REMOVAL PLAN												

2.	Minimum soil standards for plant sizes are provided in
	accordance with the Table below.

Tree Size	Height	Spread	Min Soil Area	Min soil depth
Large trees	>12m	>8m	10 × 10m	1200mm
Medium trees	8-12m	4-8m	6 x 6m	1000mm
Small trees	5-8m	<4m	3.5 x 3.5m	800mm
Shrubs	-	-	n/a	500-600mm
Groundcover		-	n/a	300-450mm
Turf	-	-	n/a	200mm

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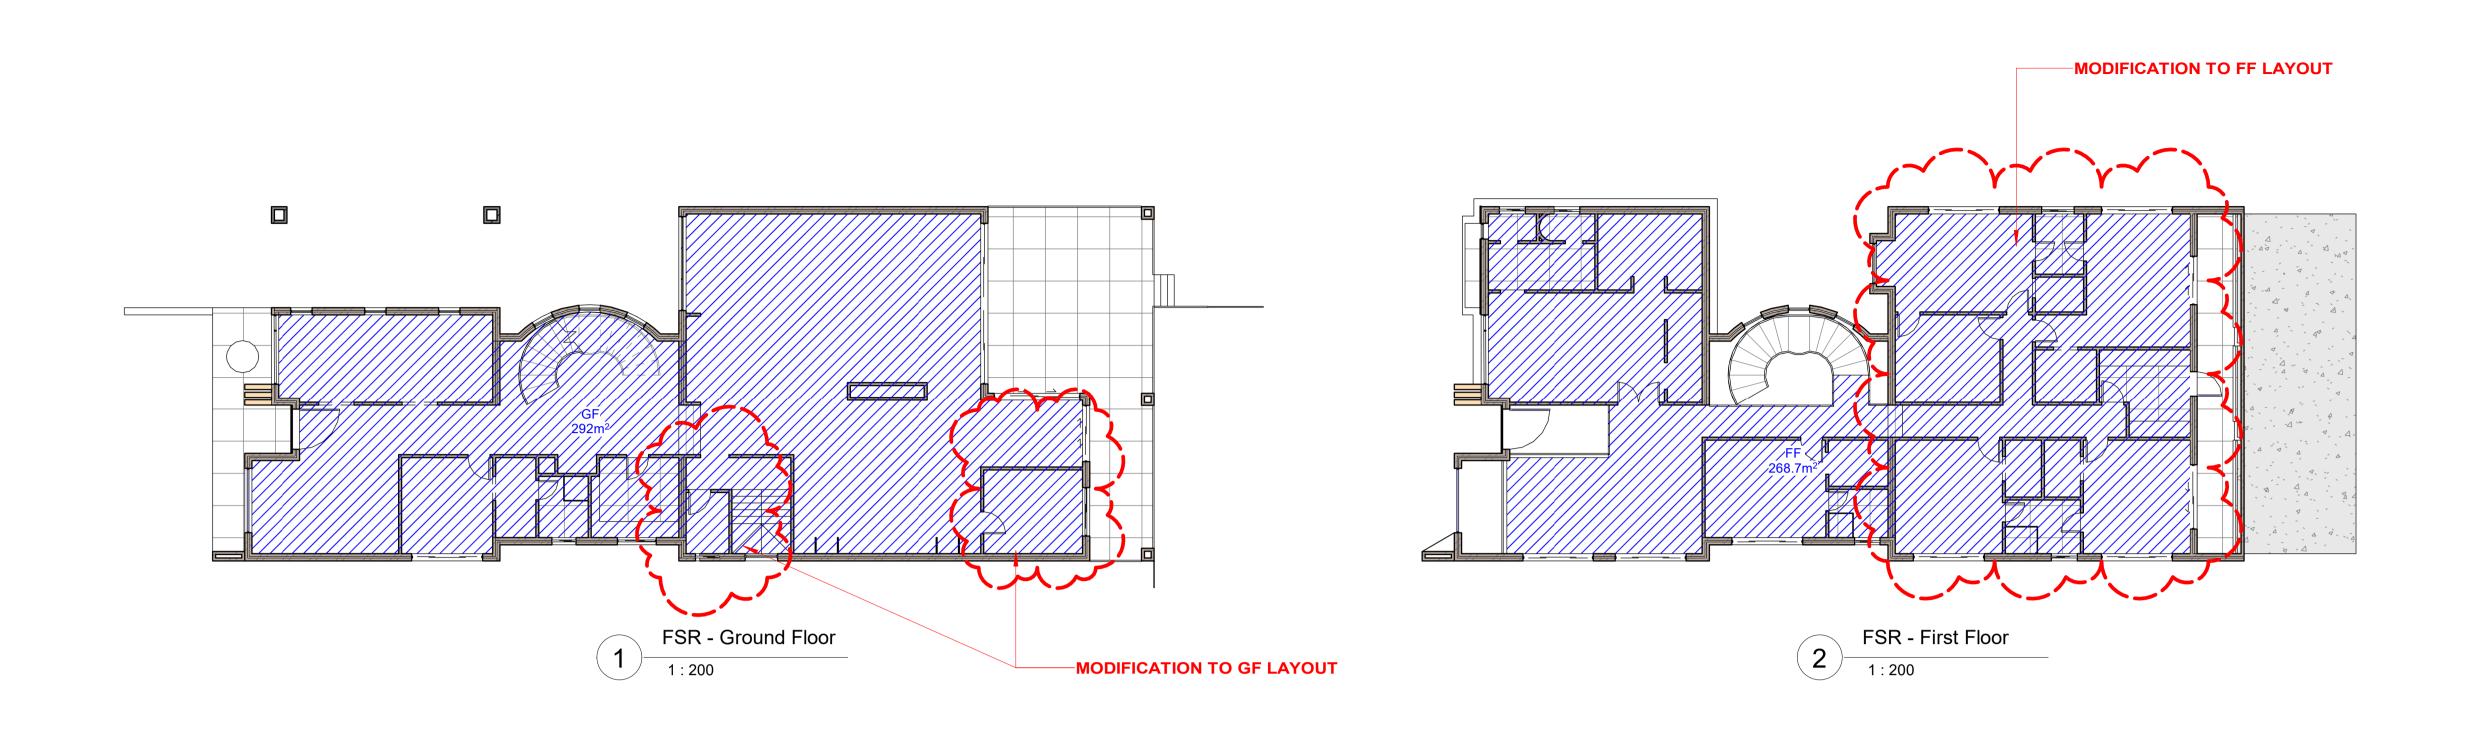
25.02.2025 AS SHOWN

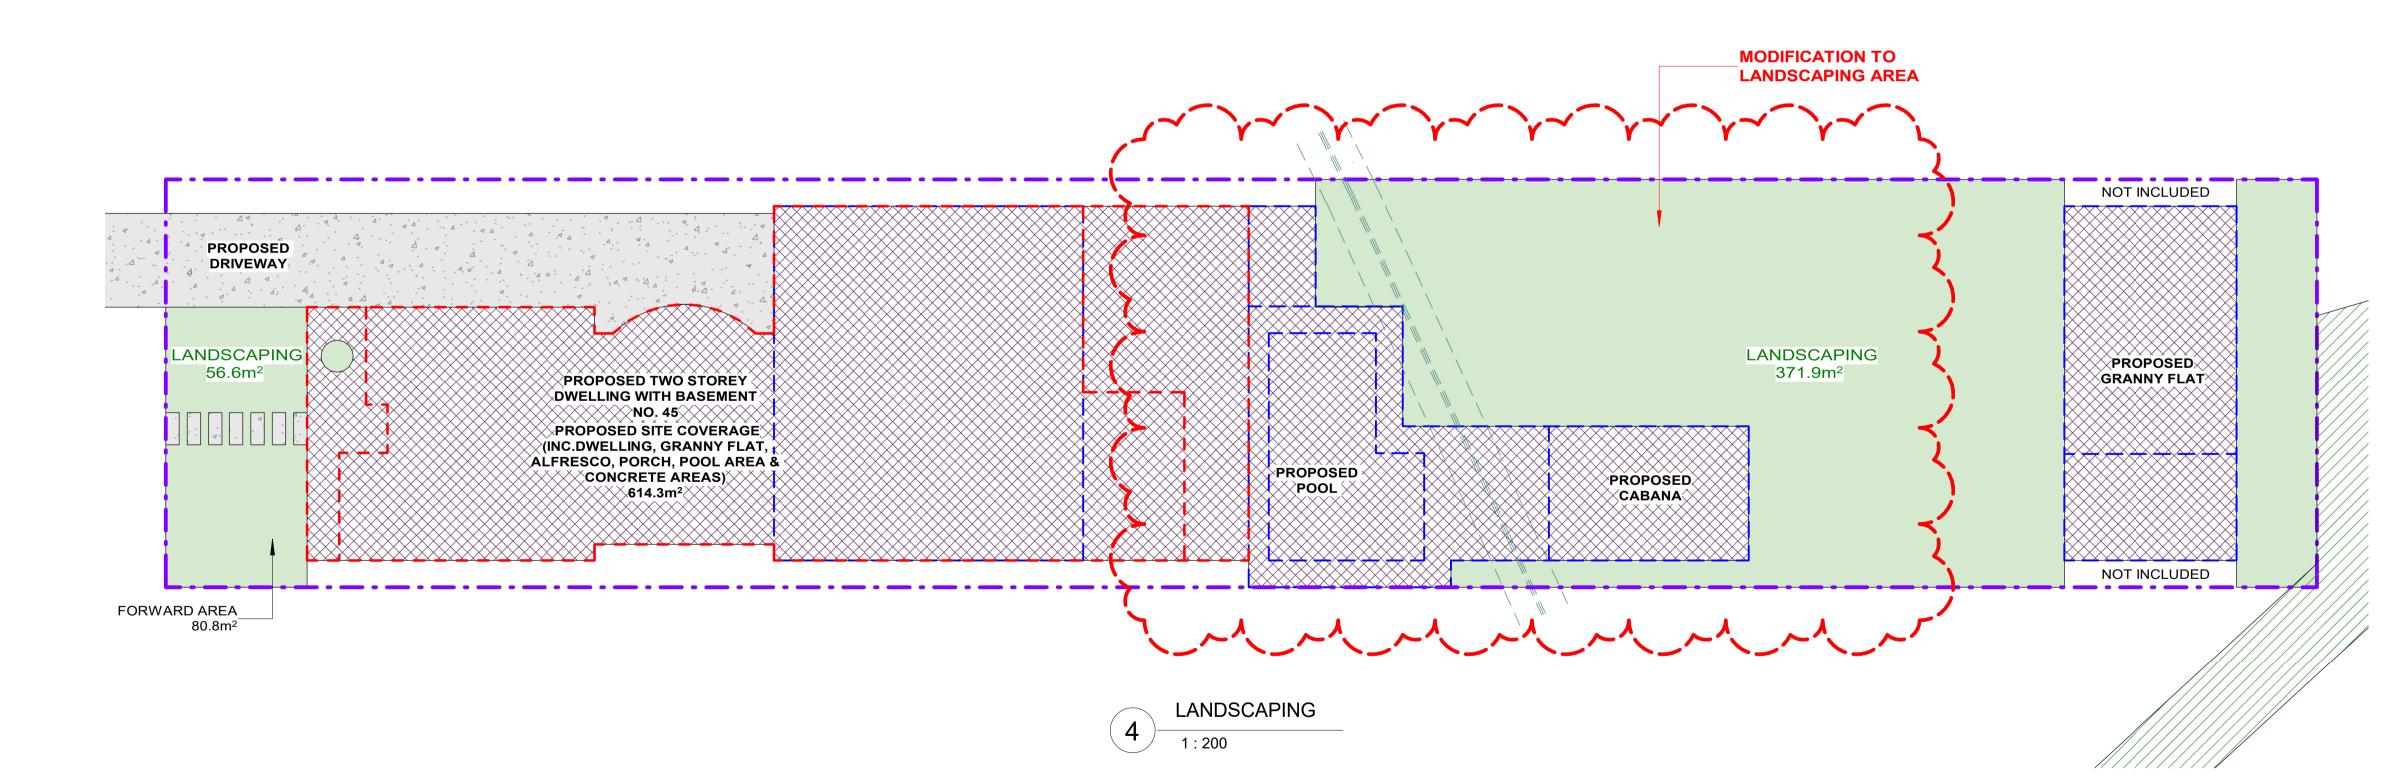
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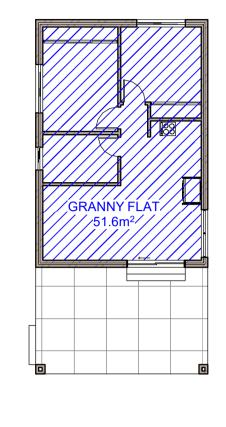
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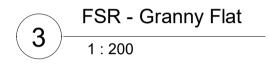
LANDSCAPING PLAN





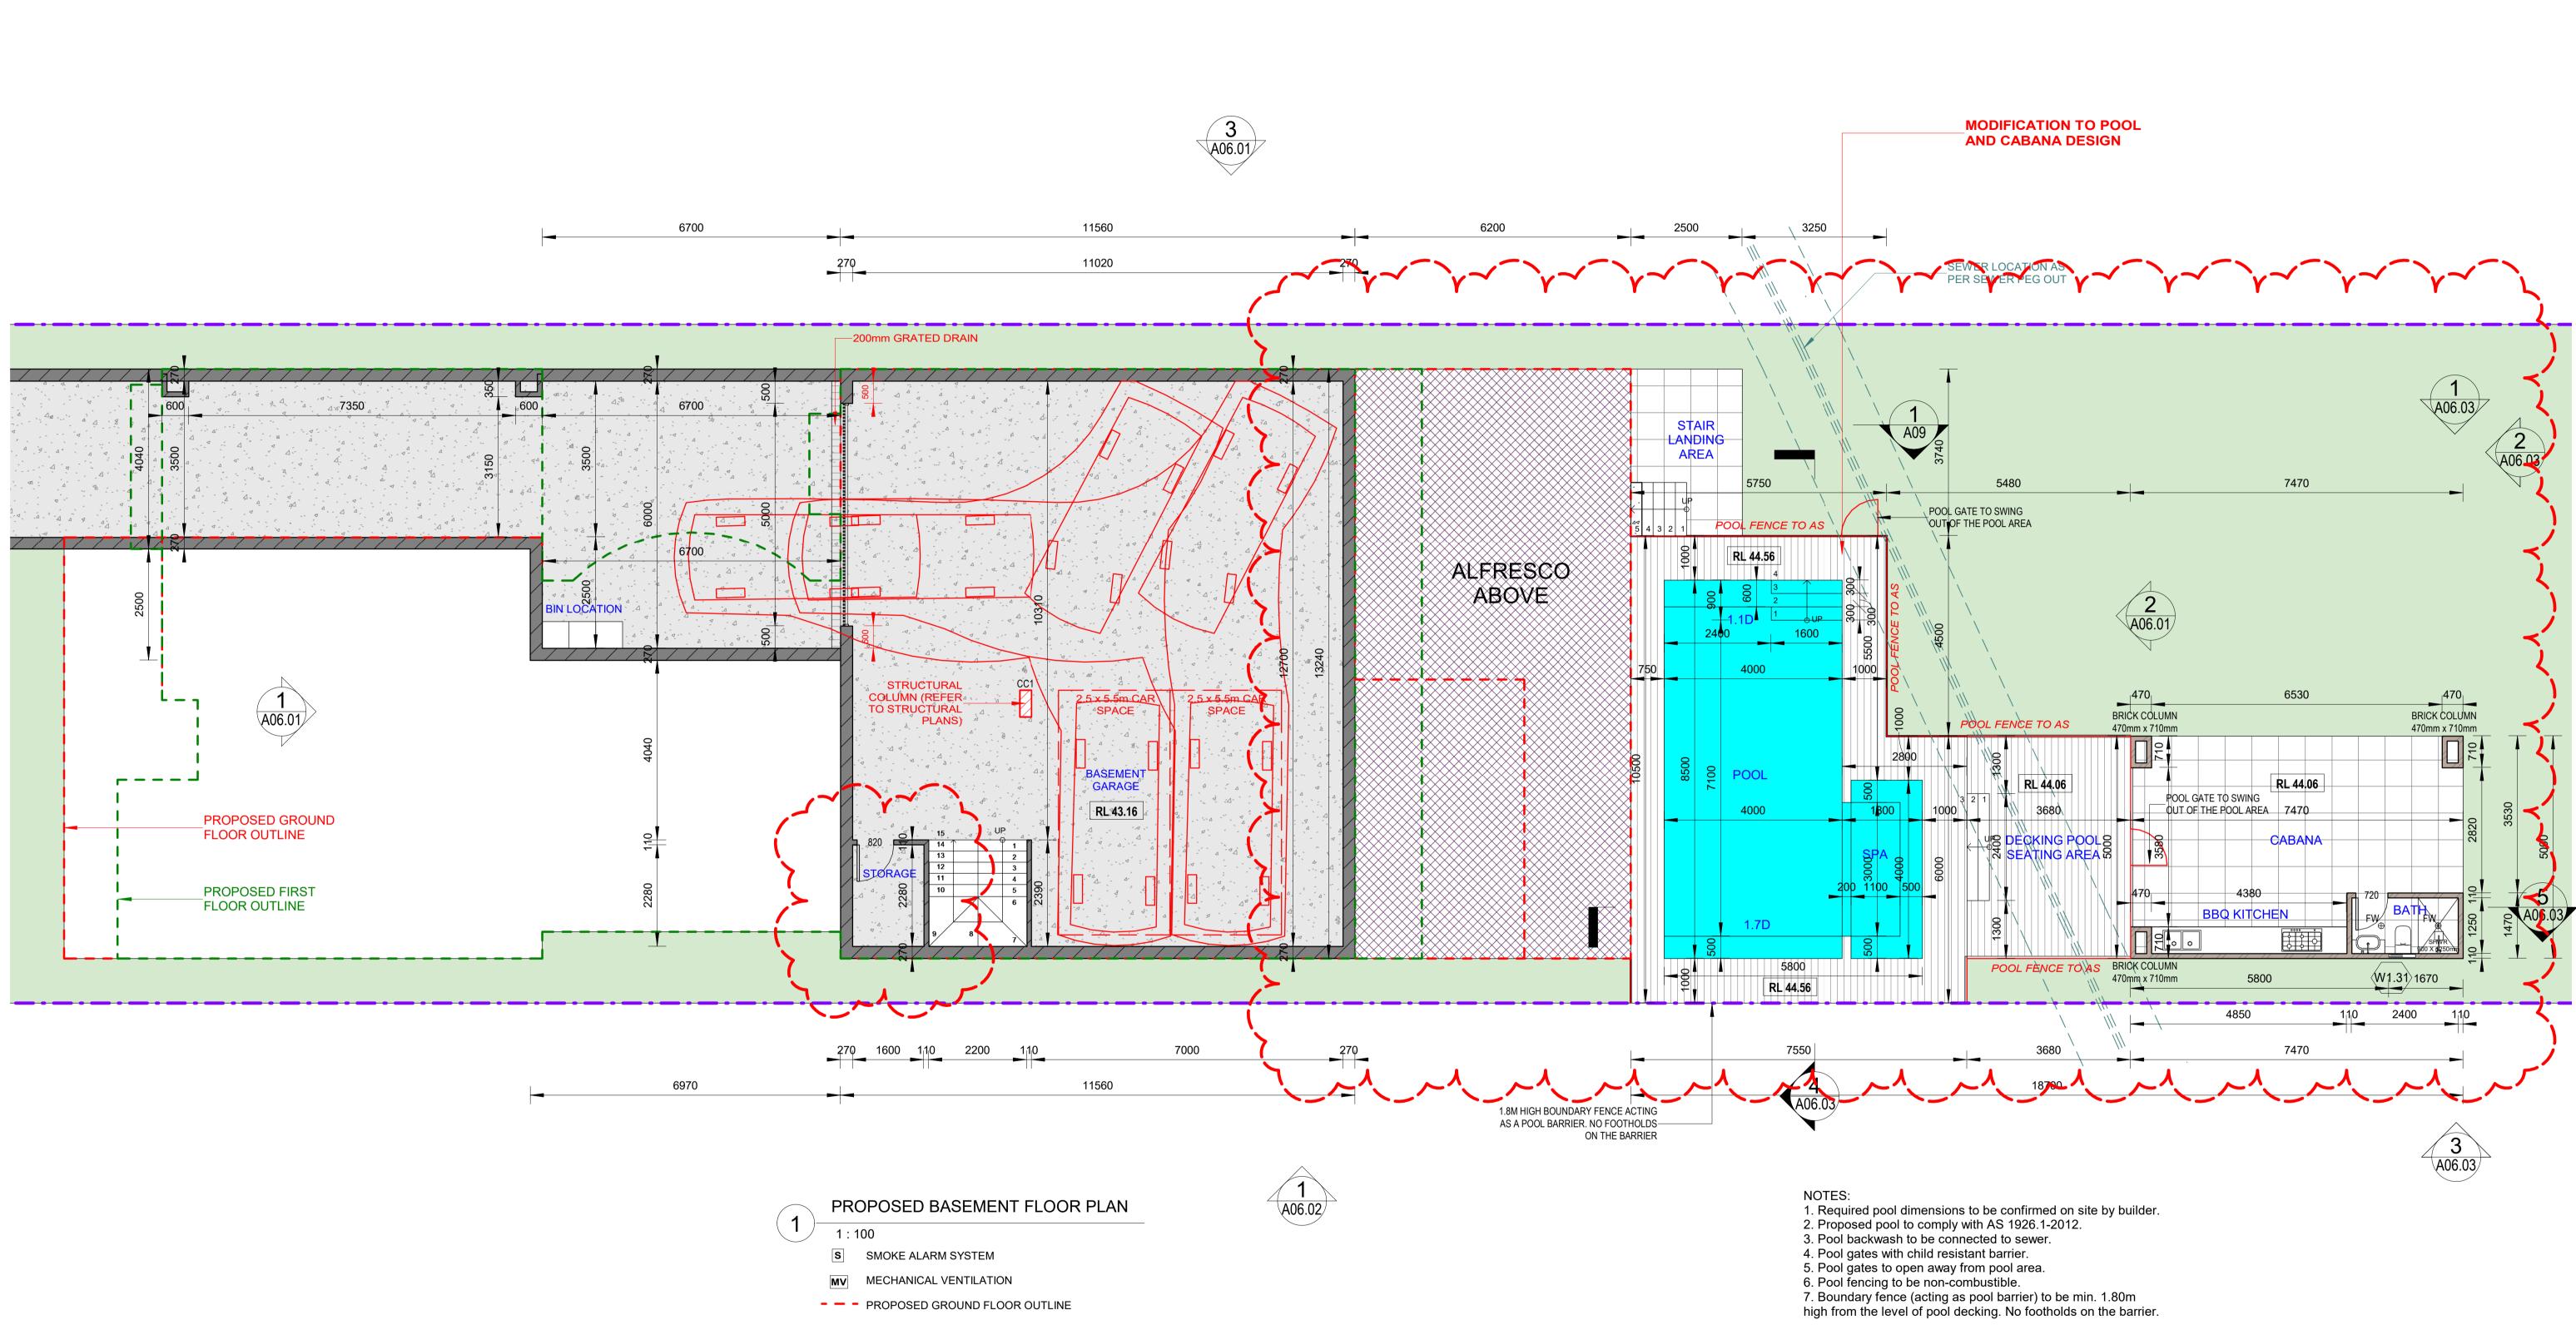
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SITE CALCULATIONS	
FLOOR AREA CALCULATIONS	
SITE AREA:	1226.3m ²
AREA OF THE PROPOSED GROUND FLOOR: AREA OF THE PROPOSED FIRST FLOOR: AREA OF THE PROPOSED GRANNY FLAT:	292m² 268.7m² 51.6m²
MAX. TOTAL FLOOR AREA	613.1m ²
50% OF SITE AREA = 0.50 x 1220.0m ² PROPOSED TOTAL FLOOR AREA:	612.3m ² < 613.1m ²
SITE COVERAGE CALCULATIONS	
PROPOSED SITE COVERAGE: (INC. DWELLING, GRANNY FLAT, PORCH, ALFRESCO, POOL AREA & CONCRETE)	626.4m ² (51.3%)
LANDSCAPING CALCULATIONS	
MIN. LANDSC. FORWARD OF BUILDING LINE: 45% OF THE AREA OF THE LOT FORWARD OF THE BUILDING LINE= 0.45 x 80.8m ²	36.4m ²
PROPOSED LANDSCAPING AT FRONT:	56.6m ² > 36.4m ²
PROPOSED LANDSCAPING AT REAR:	371.9m²
PROPOSED TOTAL LANDSCAPING AREA:	428.5m ² (34.9%)
FRONT IMPERVIOUS AREA CALCULATION	
MAX. FRONT IMPERVIOUS AREA: 55% OF THE AREA OF THE LOT FORWARD OF THE BUILDING LINE = 0.55 x 80.8m ²	44.44m ²
PROPOSED FRONT IMPERVIOUS AREA:	23.6m ² < 44.44m ² (29.21%)

OWN.	PROPOSED TWO STOREY DWELLING WITH BASEMENT, POOL & SECONDARY DWELLING	JOB NUMBER: 23611	DWG NUMBER: A01.05	ORIGINAL SIZE: A2
228 n.au	45 HILLCREST AVE, GREENACRE LOT 1, DP 21703	DESIGNED BY:	DATE: 25.02.2025	
	SITE CALCULATIONS	DRAWN BY: A.N.	SCALE: AS SHOWN	$\backslash /$

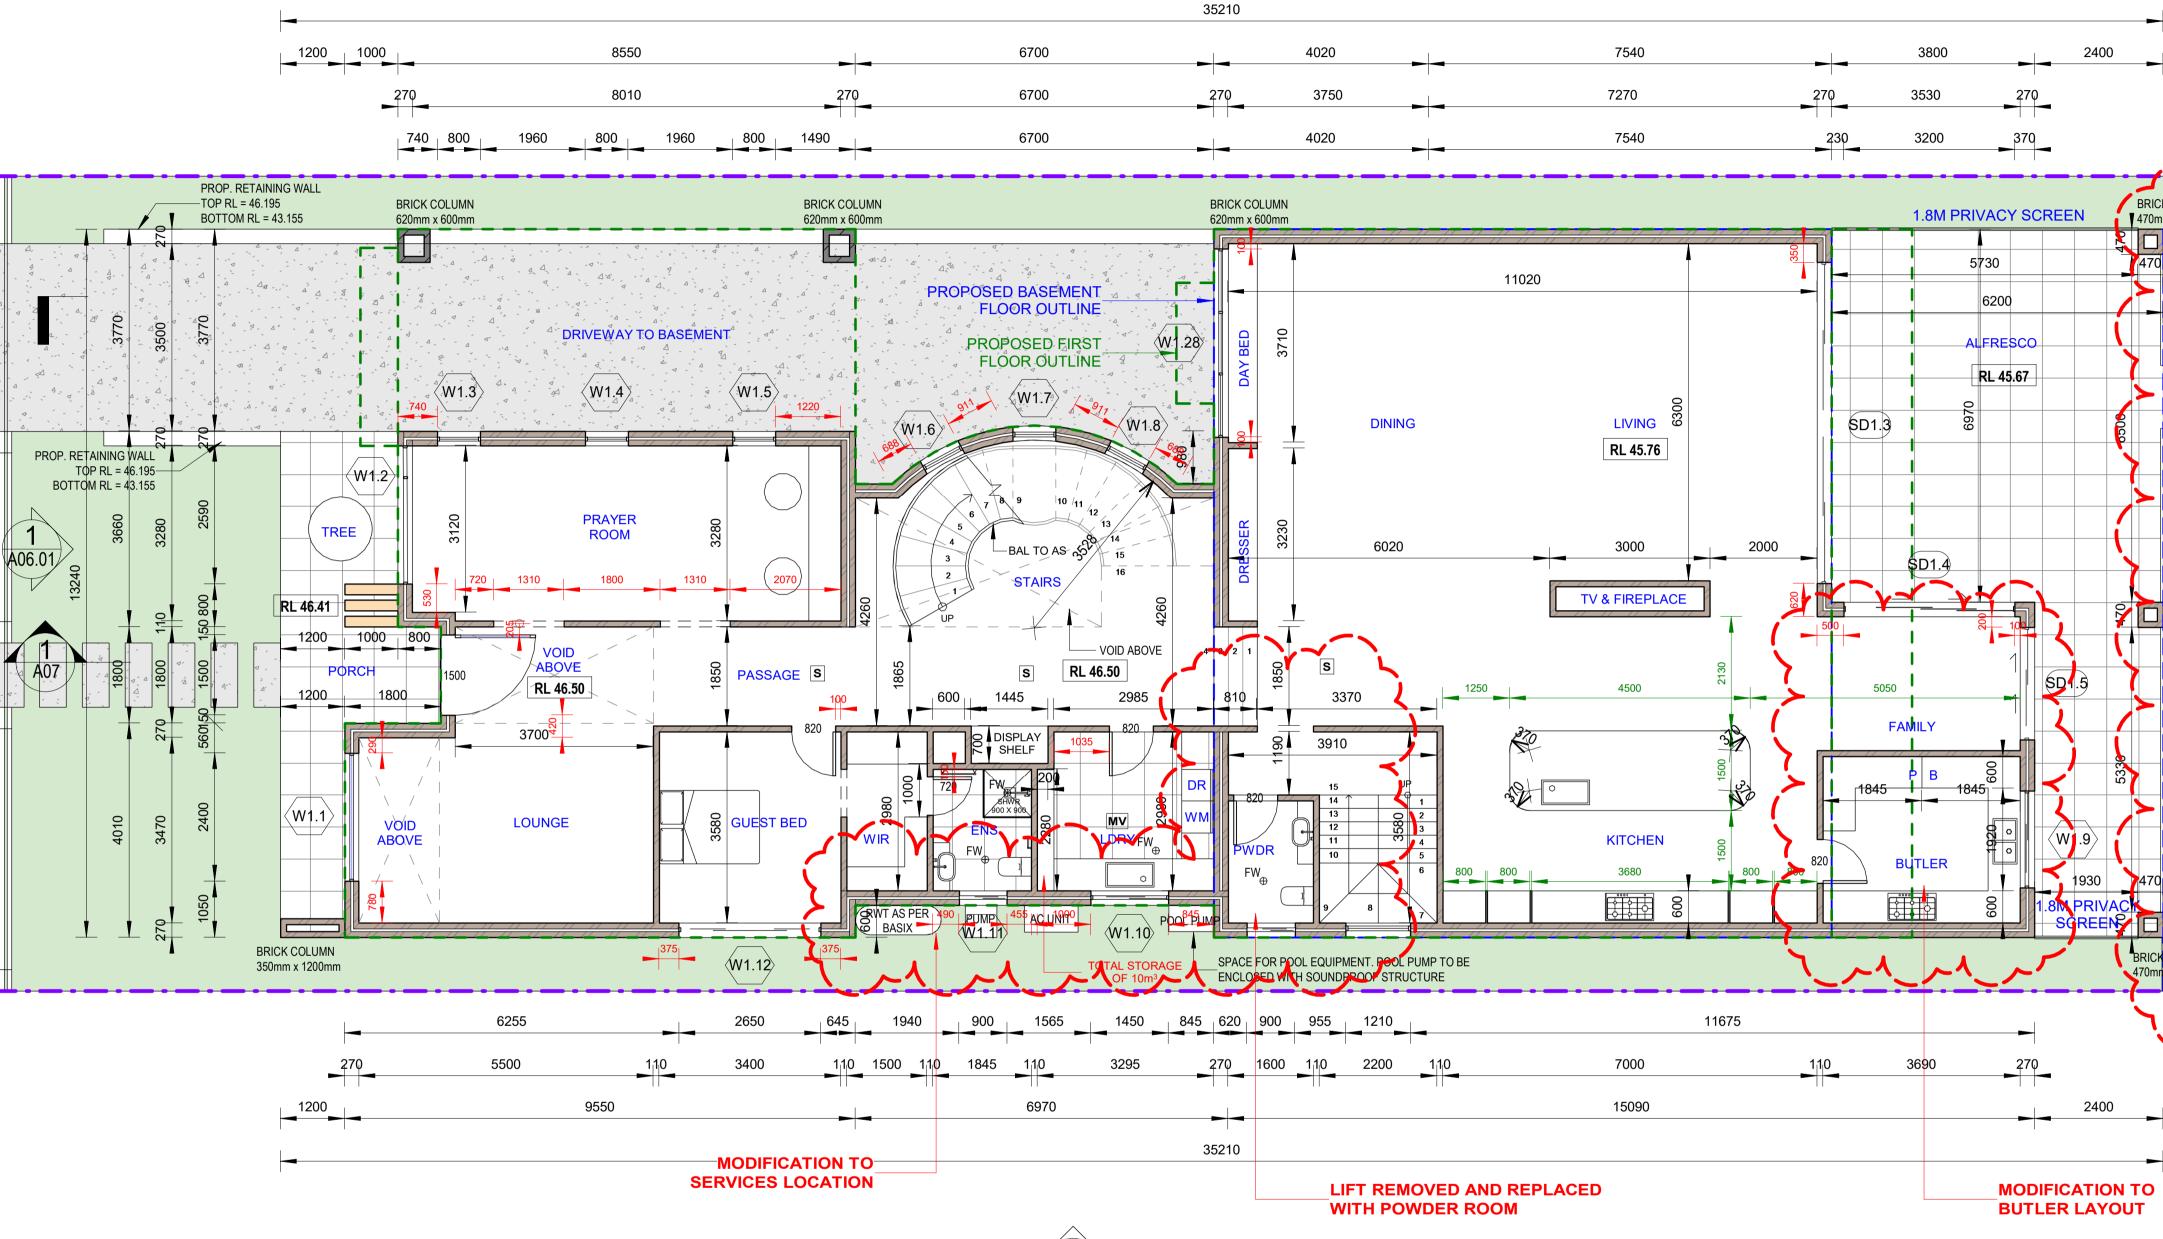


- - - PROPOSED GROUND FLOOR OUTLINE - - PROPOSED FIRST FLOOR OUTLINE

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606 228 n.com.au	45 HILLCREST AVE, GREENACRE LOT 1, DP 21703	DESIGNED BY:	DATE: 25.02.2025	
au	PROPOSED BASEMENT FLOOR PLAN	DRAWN BY:	SCALE: AS SHOWN	





PROPOSED GROUND FLOOR PLAN

1 : 100

- S SMOKE ALARM SYSTEM
- MV MECHANICAL VENTILATION
- - PROPOSED BASEMENT FLOOR OUTLINE
- - PROPOSED FIRST FLOOR OUTLINE

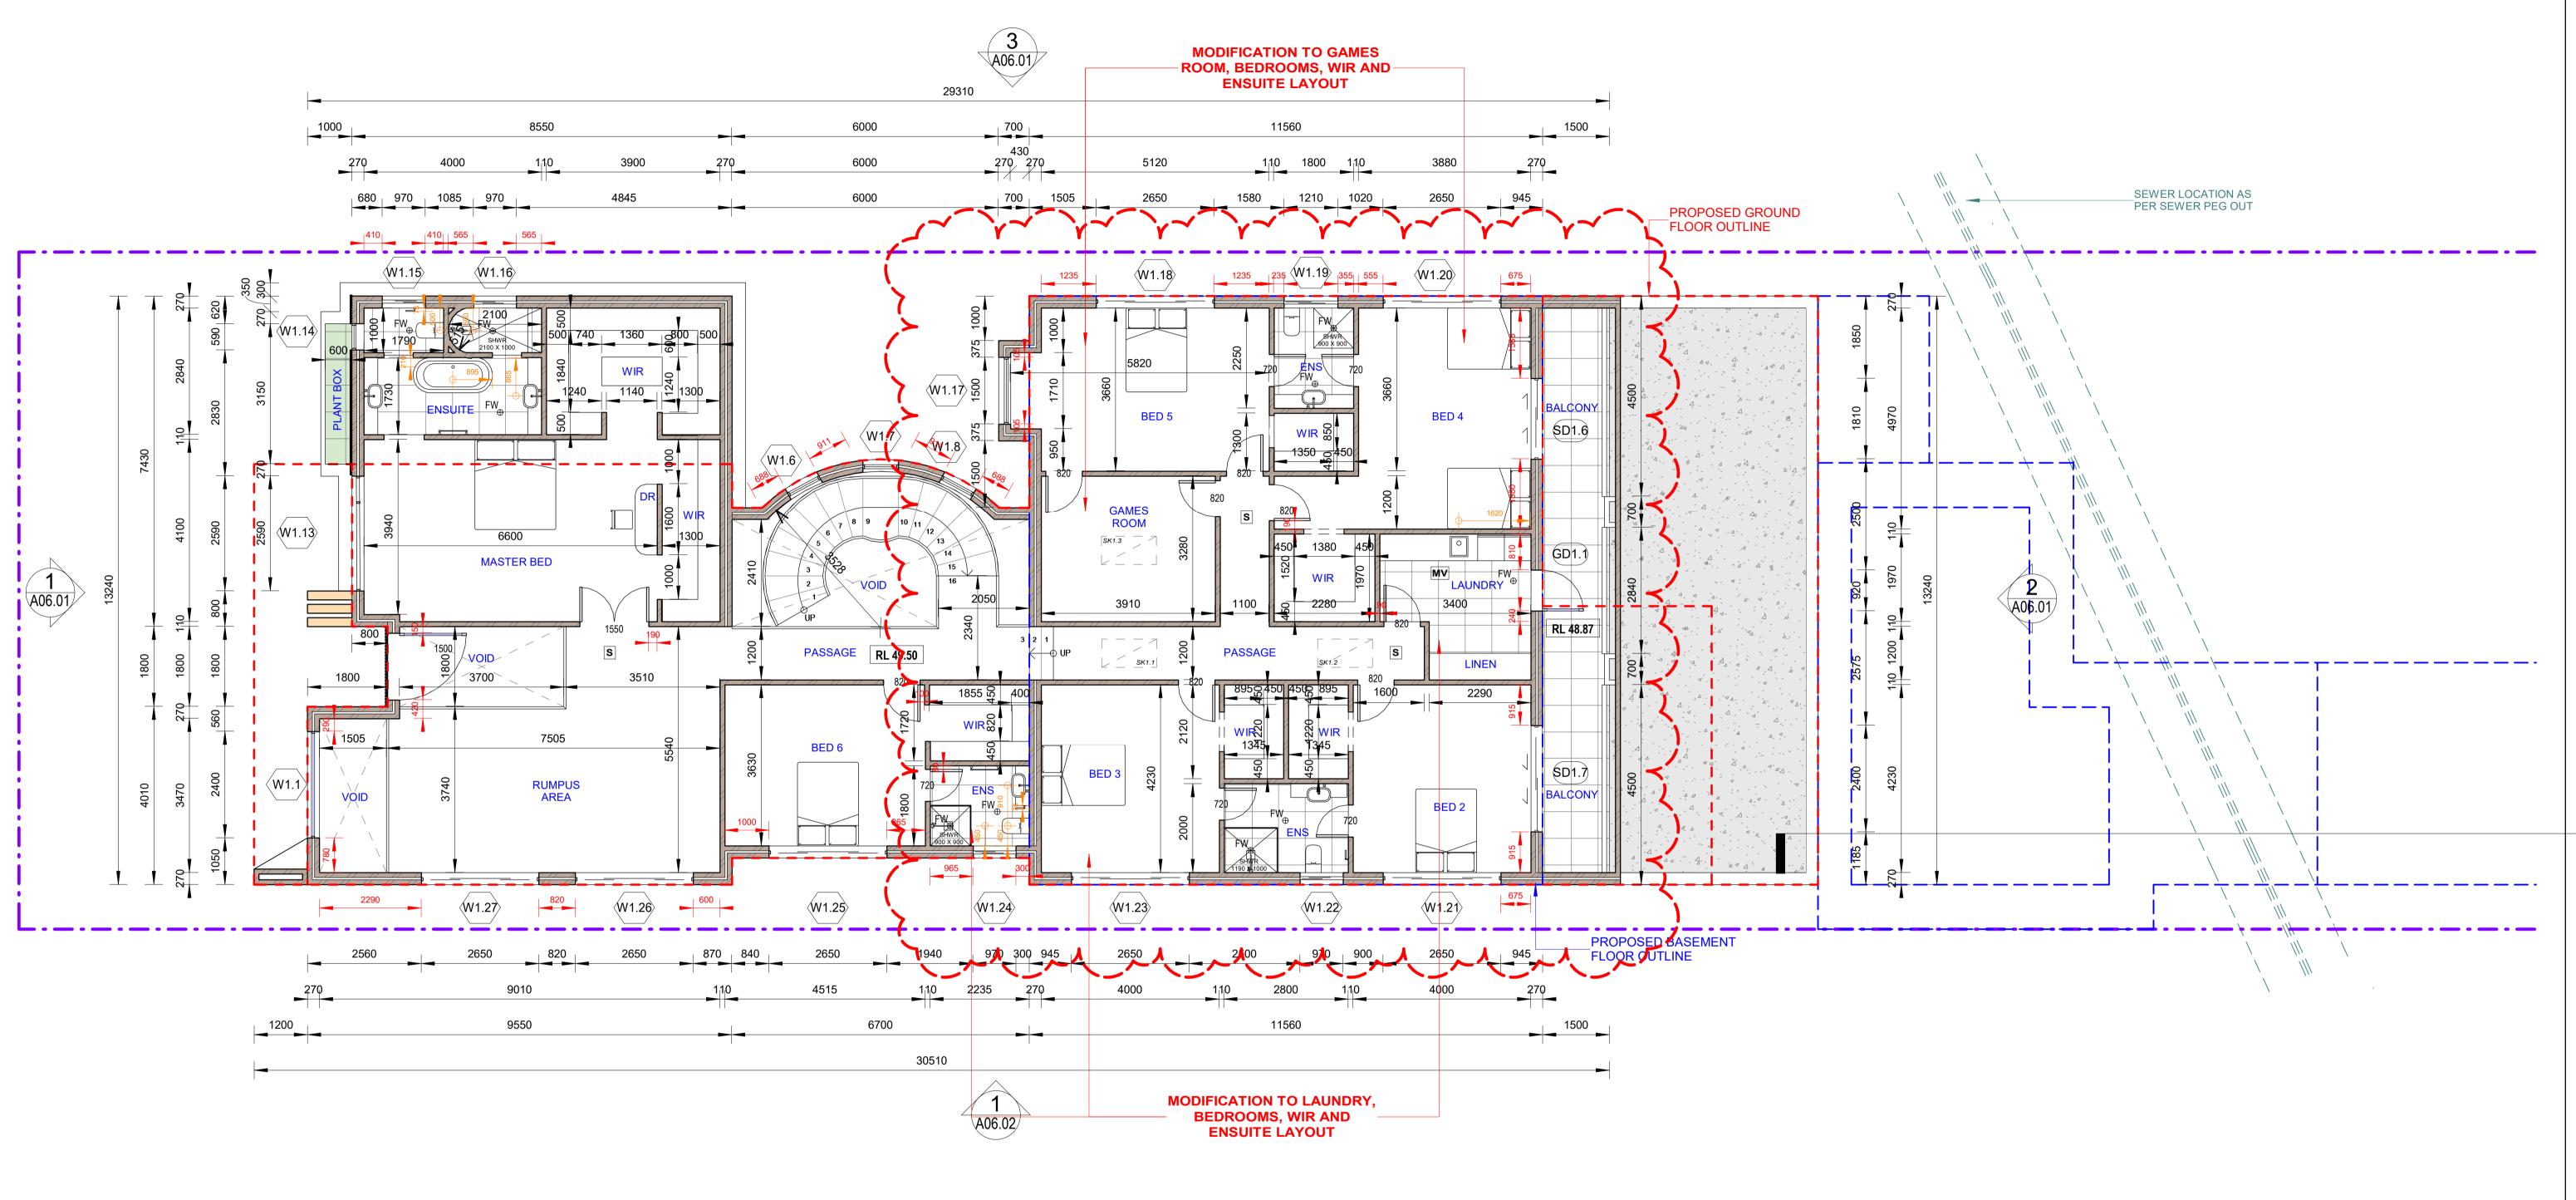
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SEWER LOCATION AS PER SEWER PEG OUT -BRICK COLUMN 470mm x 470mm 470 A09 8 8 2 A06.01 POOL 1800 1000 RL 44.06 DECKING POOL SPA 1 1 BRICK COLUMN 470mm x 470mm RL 44.56 **MODIFICATION TO POOL** AND CABANA DESIGN

	PROPOSED TWO STOREY DWELLING WITH	JOB NUMBER:	DWG NUMBER:	ORIGINAL SIZE:
070101	BASEMENT, POOL & SECONDARY DWELLING	23611	A03	A2
KSTOWN, 606 228 1.com.au	45 HILLCREST AVE, GREENACRE LOT 1, DP 21703	DESIGNED BY:	DATE: 25.02.2025	
		A.N.	25.02.2025	
	PROPOSED GROUND FLOOR PLAN	DRAWN BY:	SCALE:	\setminus $/$
		A.N.	AS SHOWN	



PROPOSED FIRST FLOOR PLAN

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(1)

SMOKE ALARM SYSTEM

MV MECHANICAL VENTILATION

---- PROPOSED BASEMENT FLOOR OUTLINE

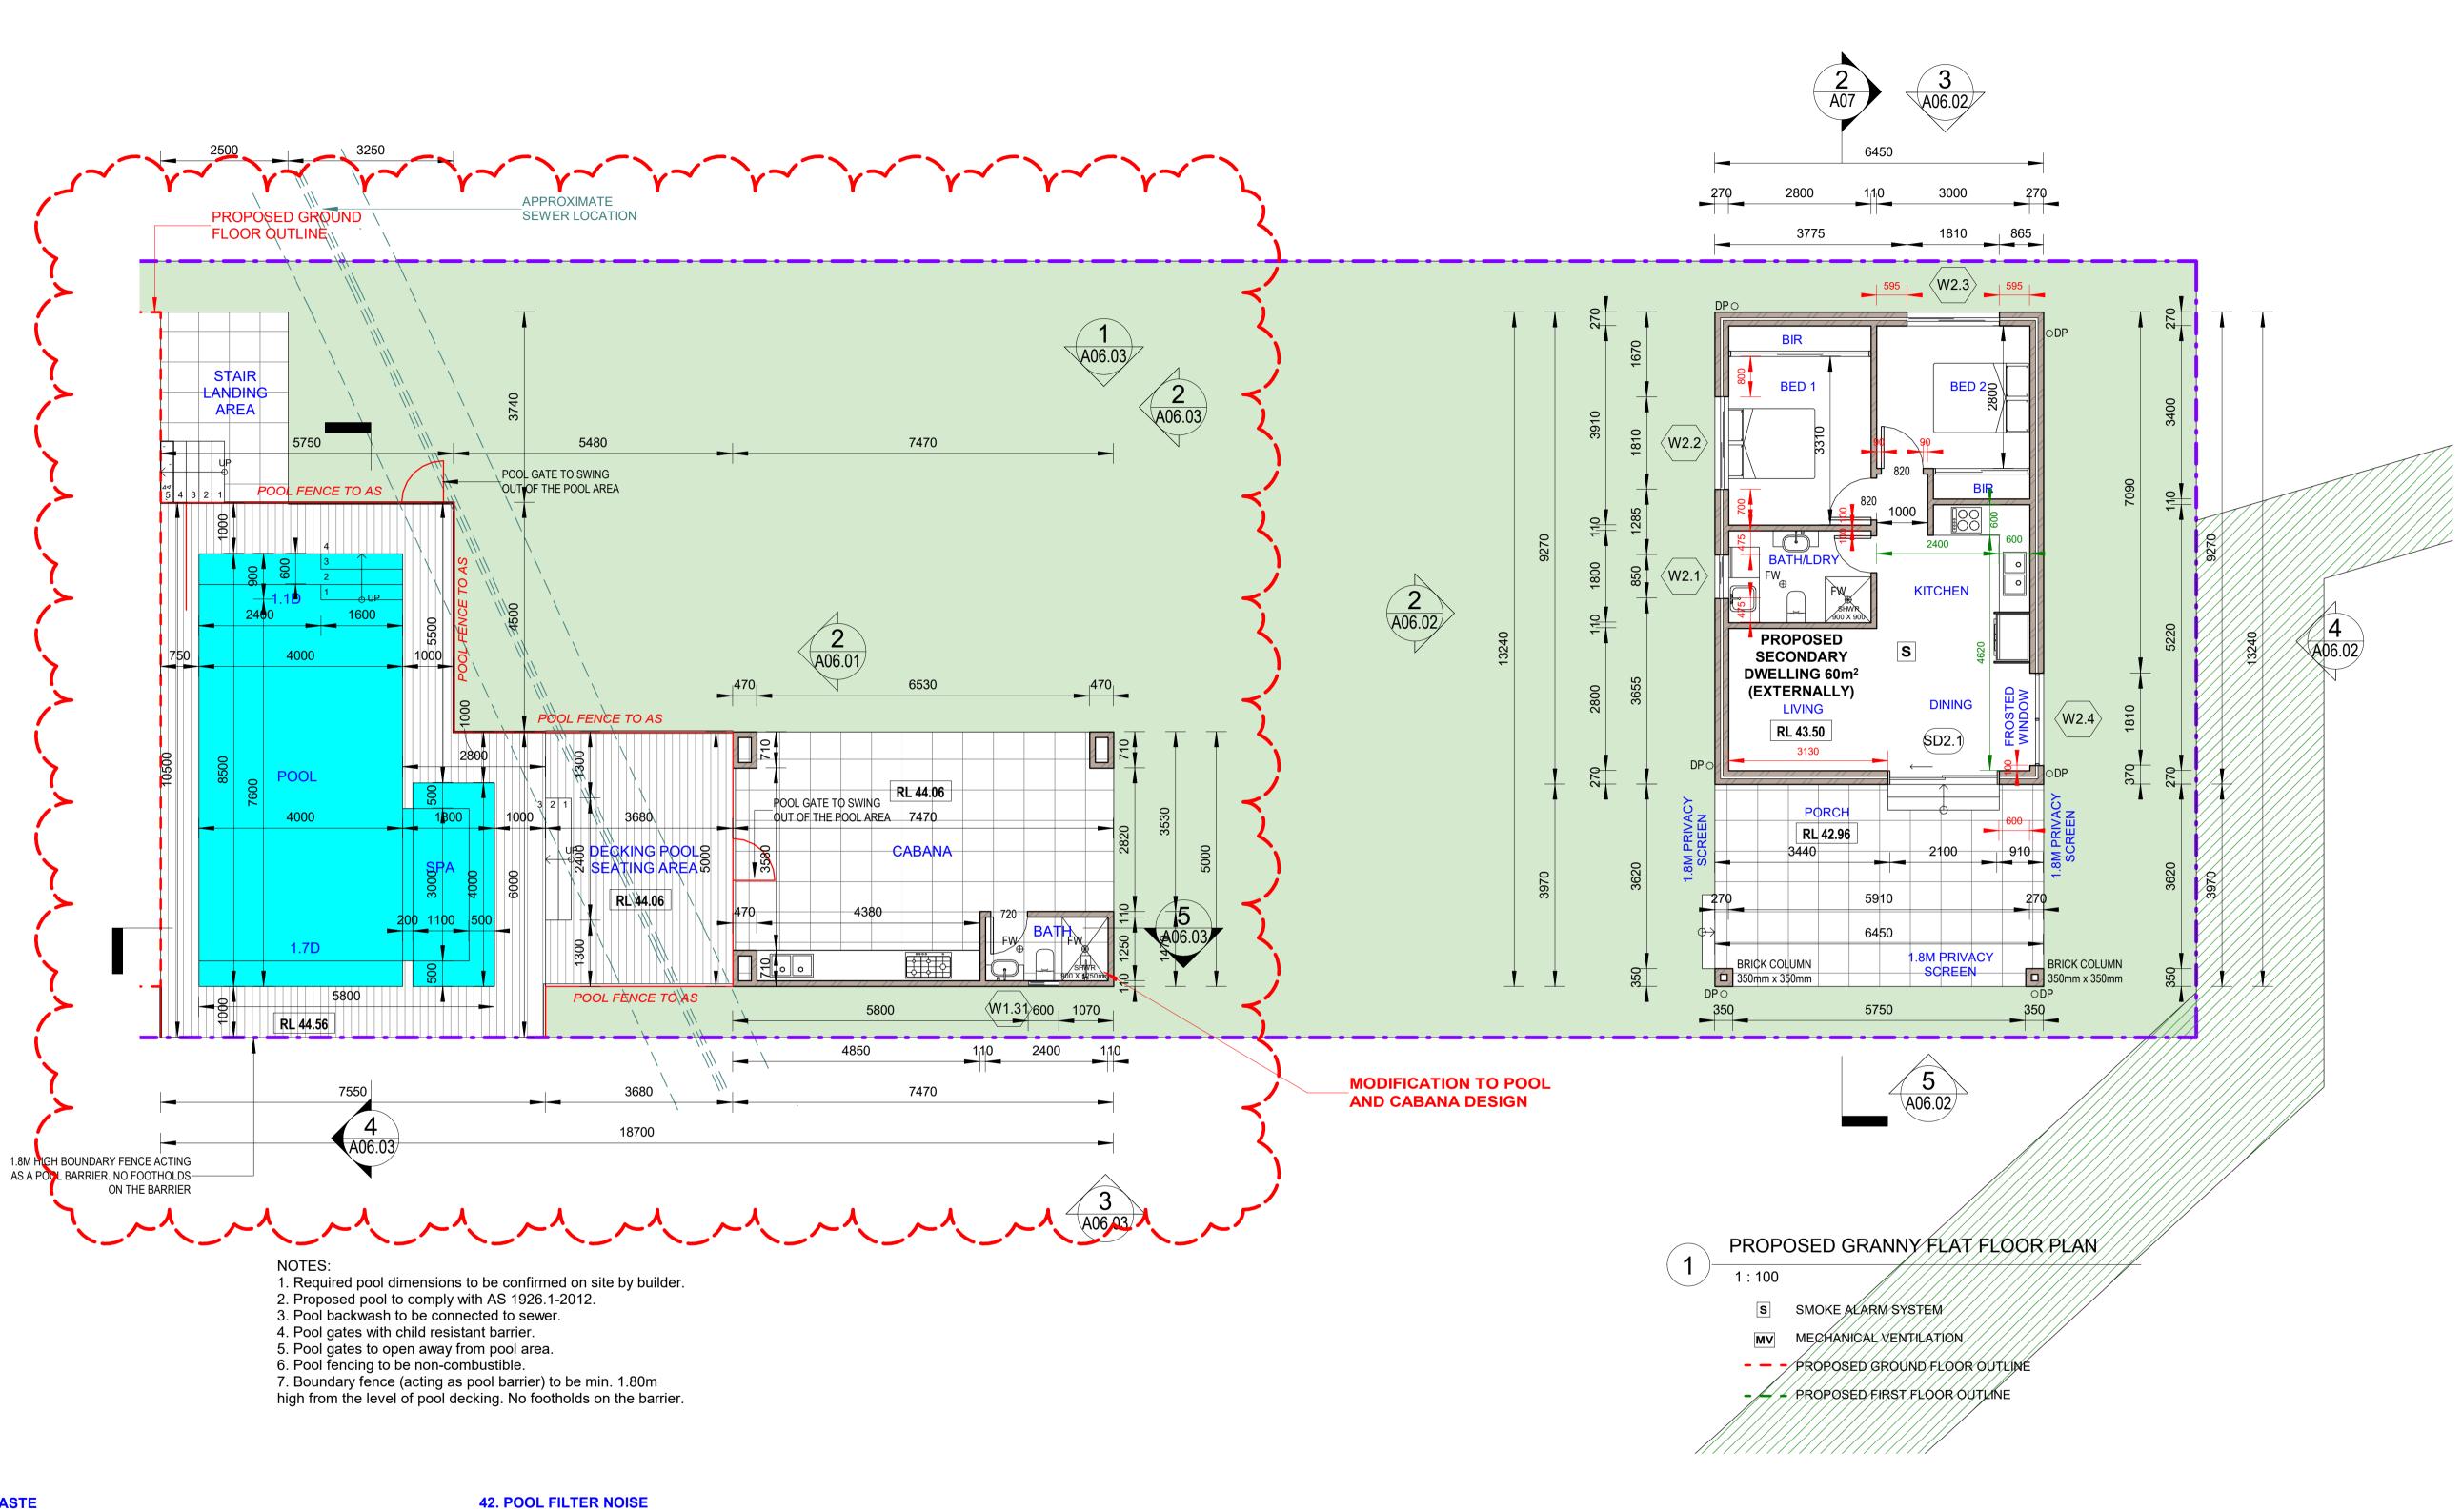
- - PROPOSED GROUND FLOOR OUTLINE

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С	05.11.2024	ADDITIONAL INFORMATION REQUESTED BY COUNCIL	DK
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		<u> </u>	25.02.2025	
	PROPOSED FIRST FLOOR PLAN	DRAWN BY:	SCALE:	
		A.N.	AS SHOWN	



DA CONDITIONS

9. SWIMMING POOL WASTE

SWIMMING POOL WASTE AND OVERFLOW WATERS MUST BE COLLECTED AND DIRECTED TO THE SEWER IN ACCORDANCE WITH THE REQUIREMENTS OF SYDNEY WATER. DETAILS MUST BE SUBMITTED WITH THE APPLICATION FOR A CONSTRUCTION CERTIFICATE AND BE APPROVED BY THE CERTIFIER BEFORE THE ISSUE OF A CONSTRUCTION CERTIFICATE.

41. POOL BARRIER

THE SWIMMING POOL IS TO BE ENCLOSED BY A CHILD RESISTANT BARRIER COMPRISING FENCES AND GATES DESIGNED, CONSTRUCTED, INSTALLED AND MAINTAINED IN ACCORDANCE WITH AUSTRALIAN STANDARD AS 1926 – 'SWIMMING POOL SAFETY PART 1: SAFETY BARRIERS FOR SWIMMING POOLS'.

A NOTICE CONTAINING THE WORDS: • "YOUNG CHILDREN SHOULD BE SUPERVISED WHEN USING THIS SWIMMING POOL" AND

• "POOL GATES MUST BE KEPT CLOSED AT ALL TIMES" AND

• "KEEP ARTICLES, OBJECTS AND STRUCTURES AT LEAST 900MM CLEAR OF THE POOL FENCE AT ALL TIMES"

TOGETHER WITH A SIMPLE FLOW SEQUENCE CONTAINING DETAILS OF RESUSCITATION TECHNIQUES MUST BE DISPLAYED IN A PROMINENT POSITION IN THE IMMEDIATE VICINITY OF THE POOL.

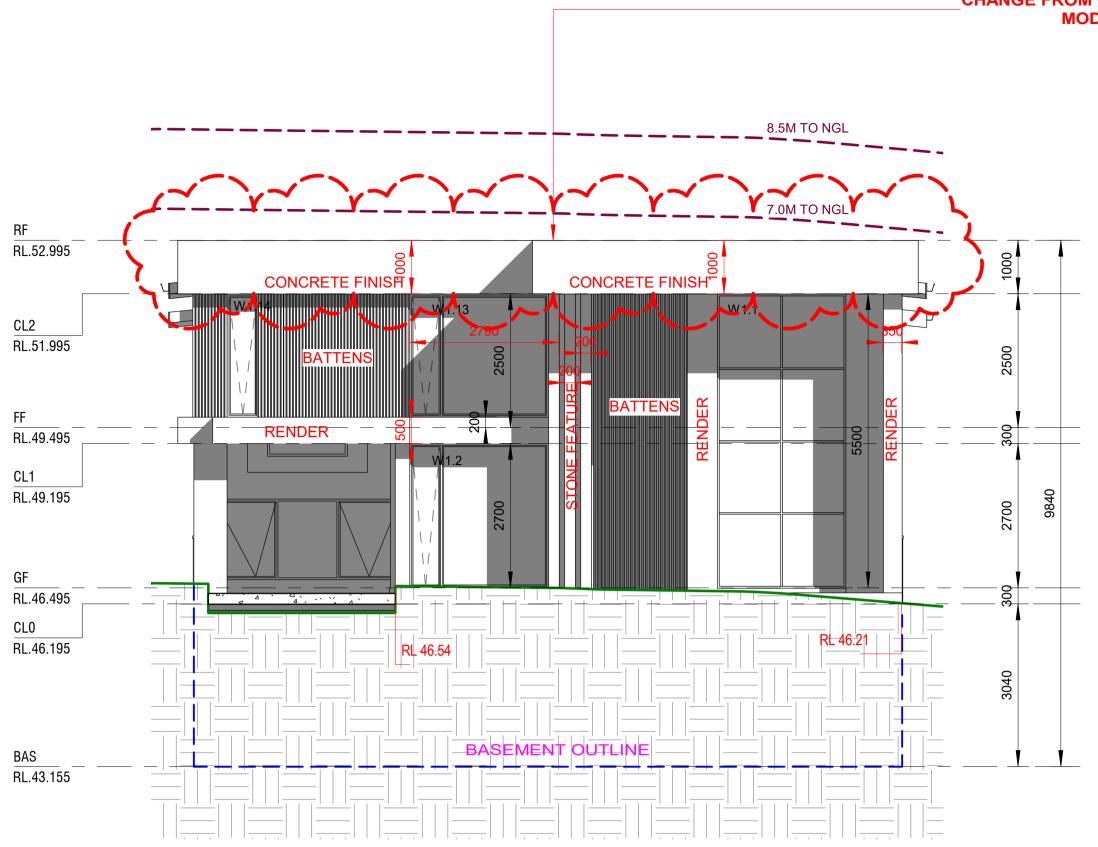
OVERFLOW AND DISCHARGE PIPES FROM THE POOL AND FILTRATION UNIT MUST BE CONNECTED TO THE SEWER.

THE USE OF THE POOL / SPA FILTER EQUIPMENT MUST NOT GIVE RISE TO OFFENSIVE NOISE AS DEFINED IN THE PROTECTION OF THE ENVIRONMENT OPERATIONS ACT 1997 AND PROTECTION OF THE ENVIRONMENT OPERATIONS (NOISE CONTROL) REGULATION 2000. ALL NOISE EMITTING EQUIPMENT MUST BE HOUSED IN AN INSULATED ENCLOSURE OR APPROPRIATELY POSITIONED SO AS TO CAUSE NO NUISANCE TO NEIGHBOURS.

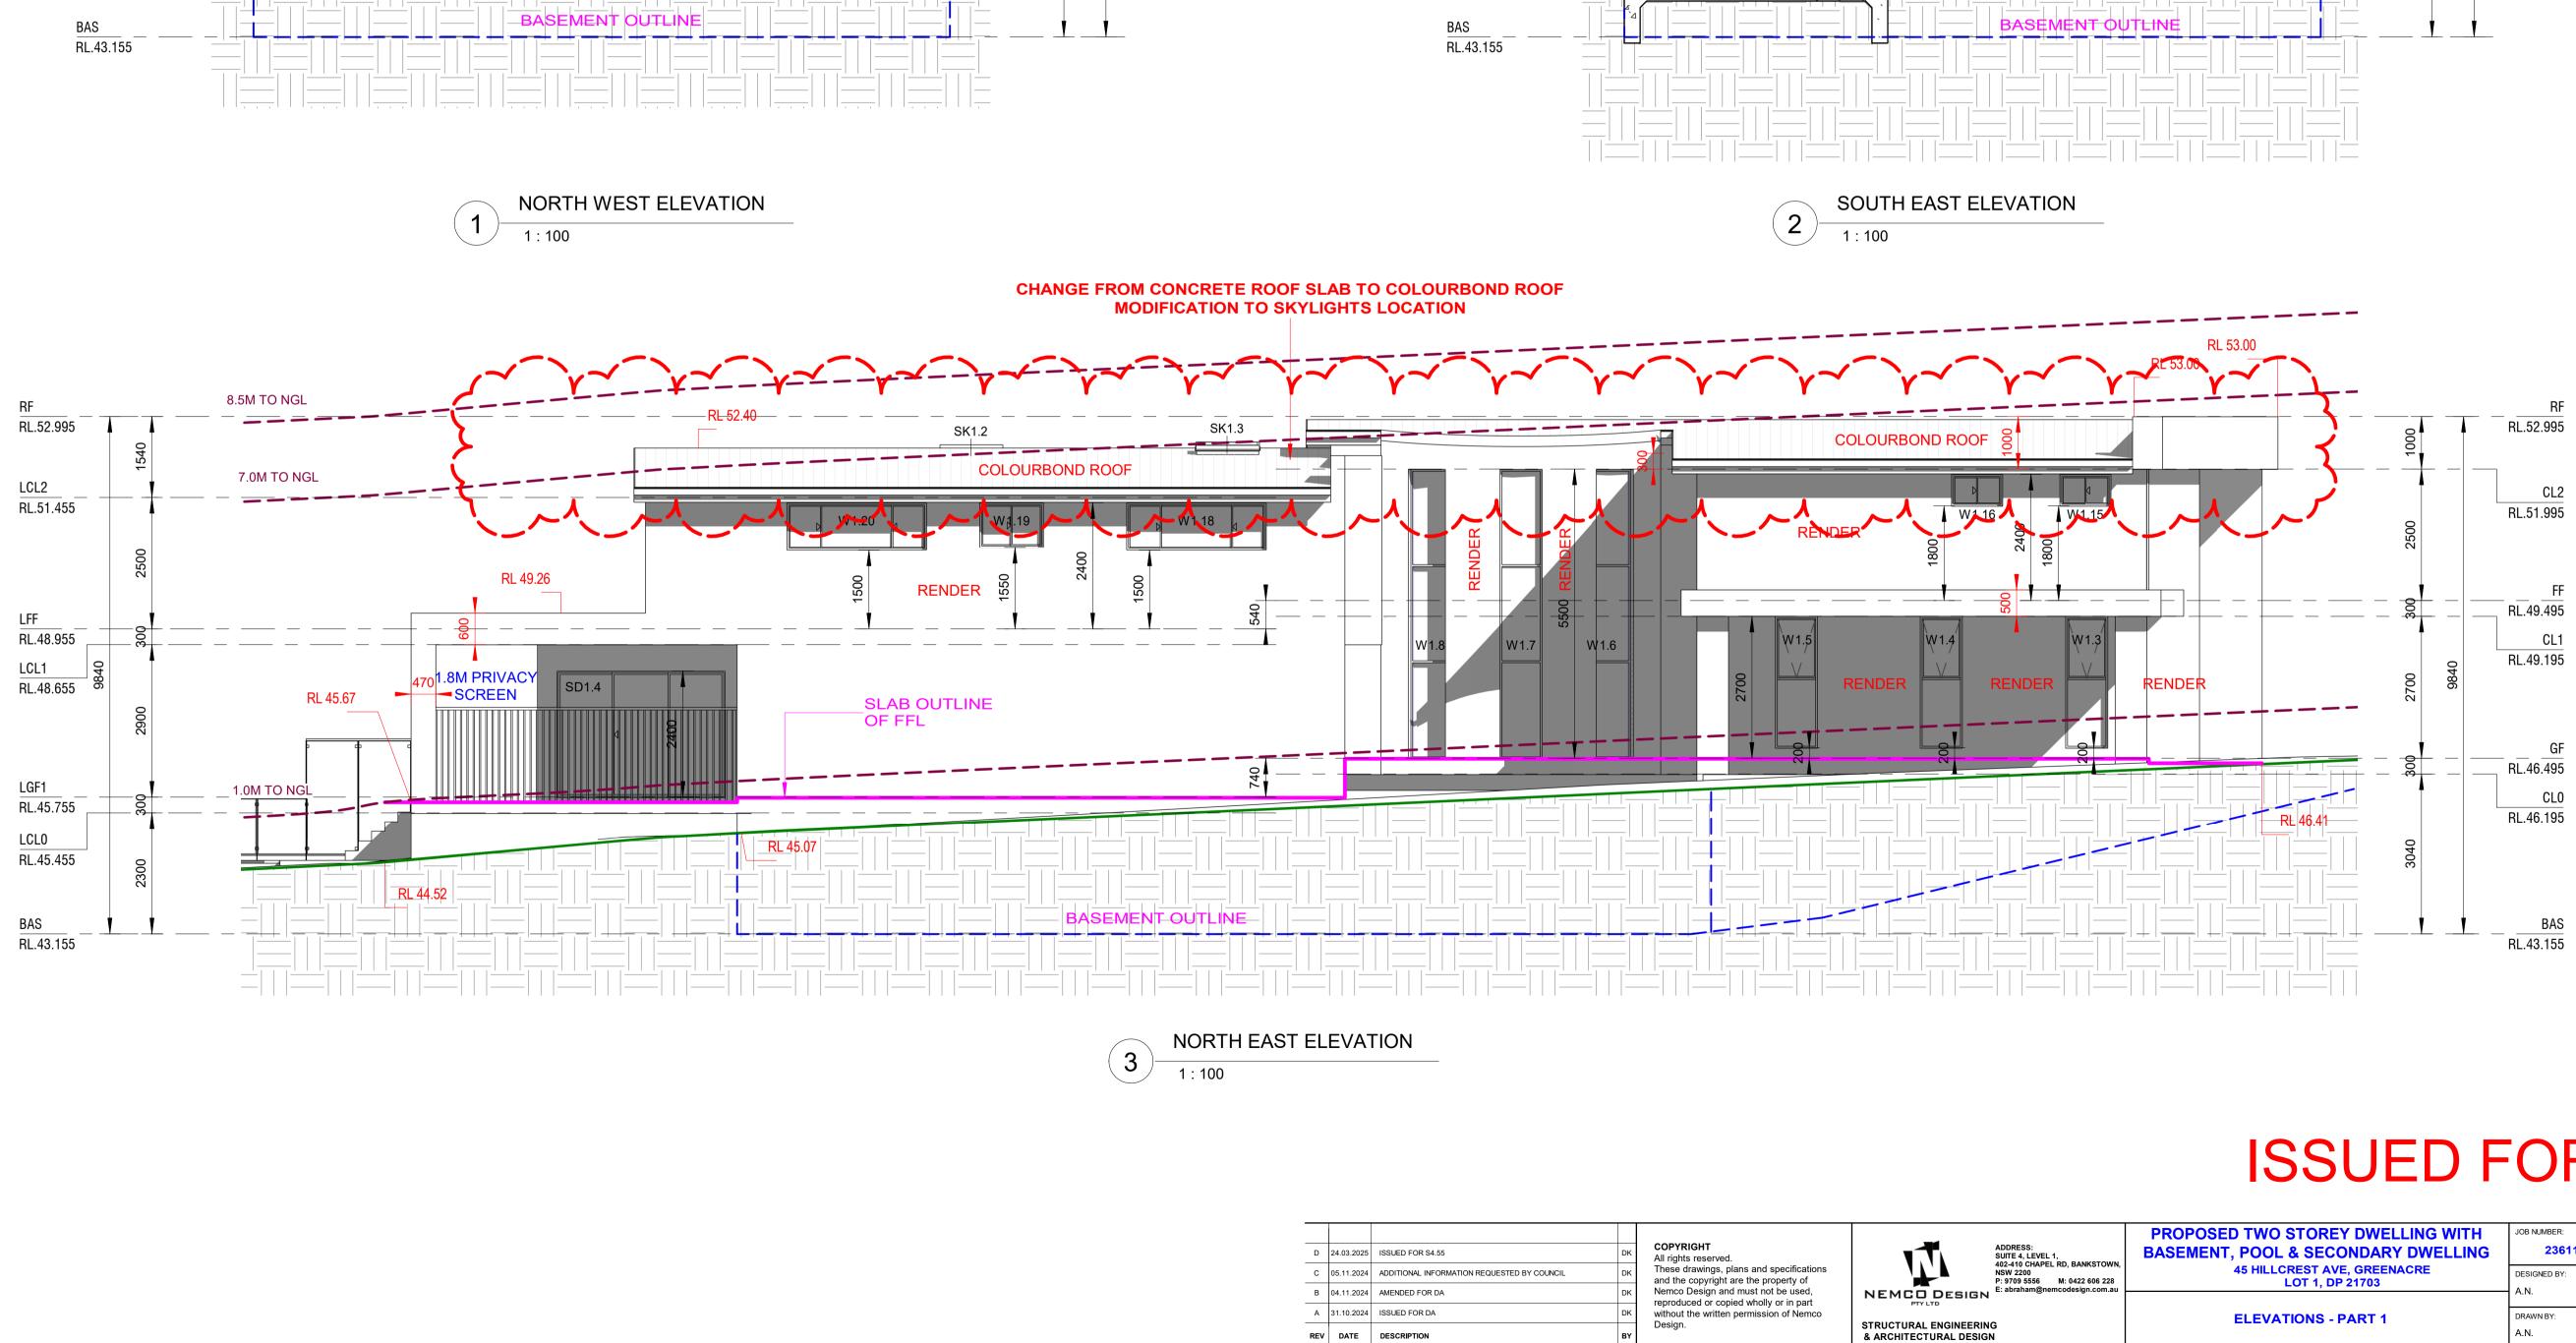
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STOWN.	PROPOSED TWO STOREY DWELLING WITH BASEMENT, POOL & SECONDARY DWELLING	JOB NUMBER: 23611	DWG NUMBER:	ORIGINAL SIZE: A2
06 228 .com.au	45 HILLCREST AVE, GREENACRE LOT 1, DP 21703	DESIGNED BY: A.N.	DATE: 25.02.2025	
	PROPOSED GRANNY FLAT	DRAWN BY: A.N.	SCALE: AS SHOWN	\bigcup

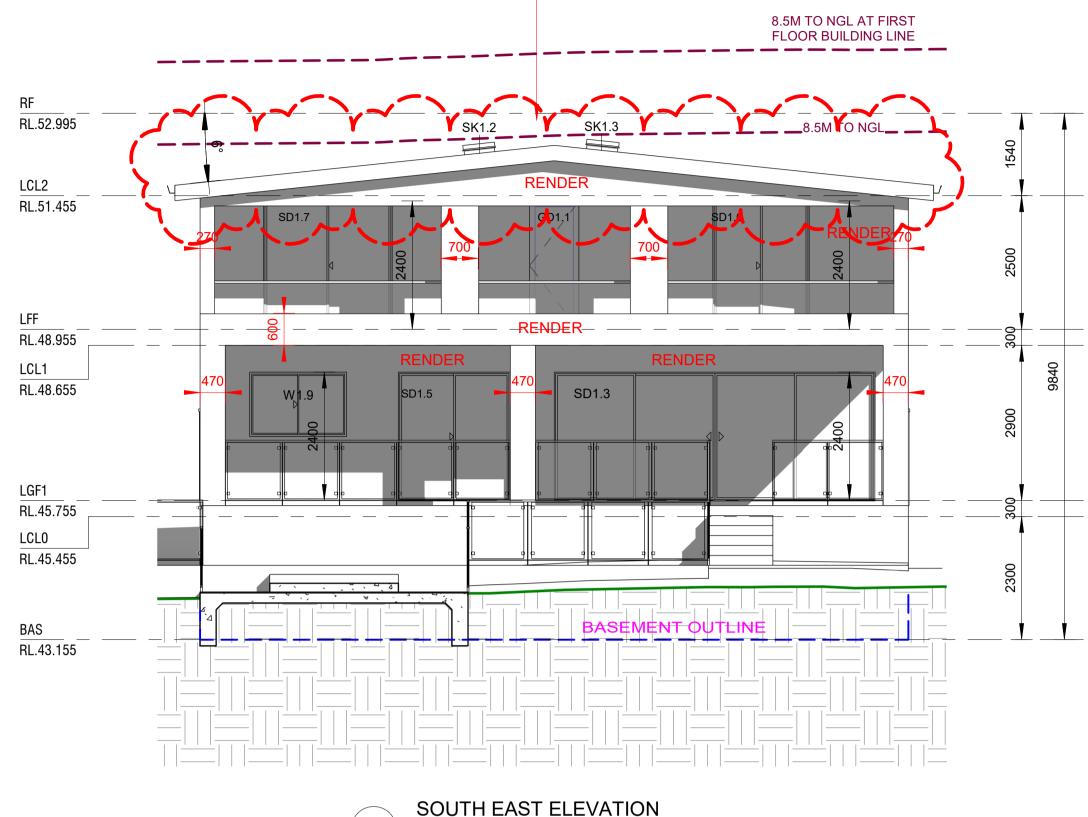






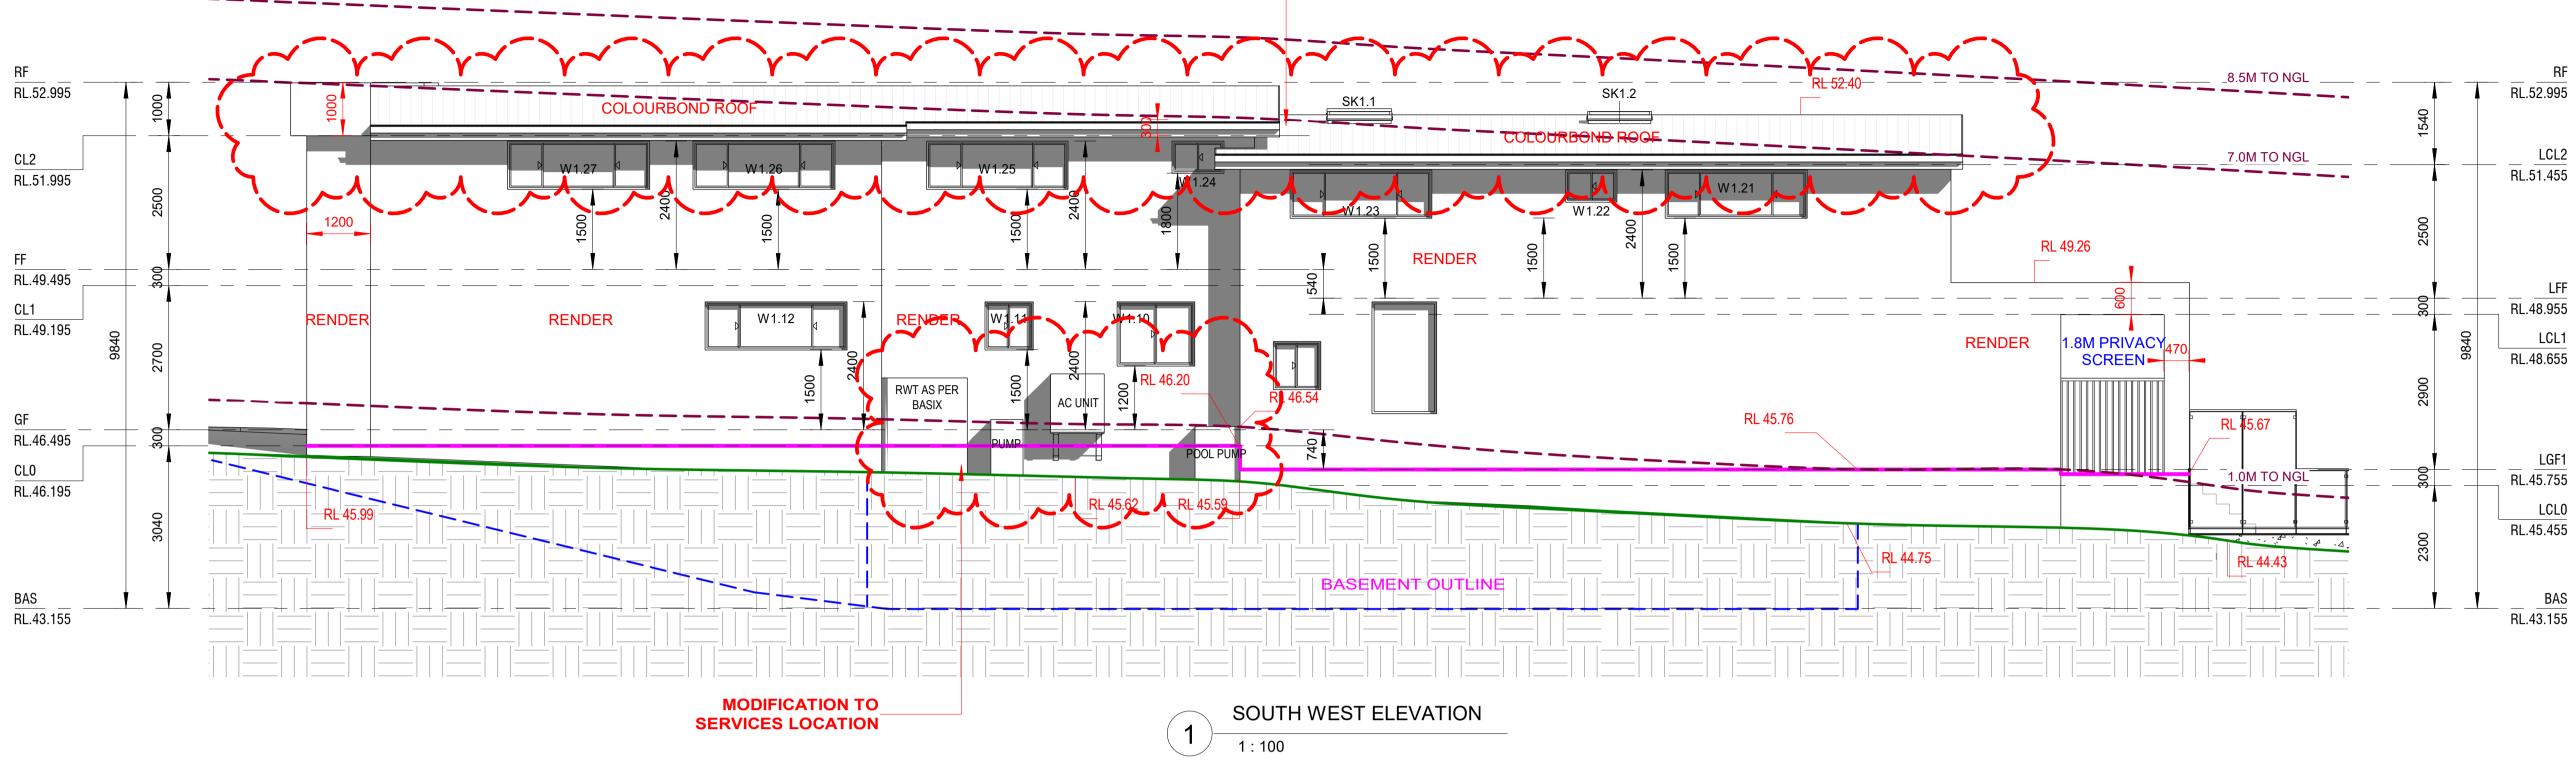
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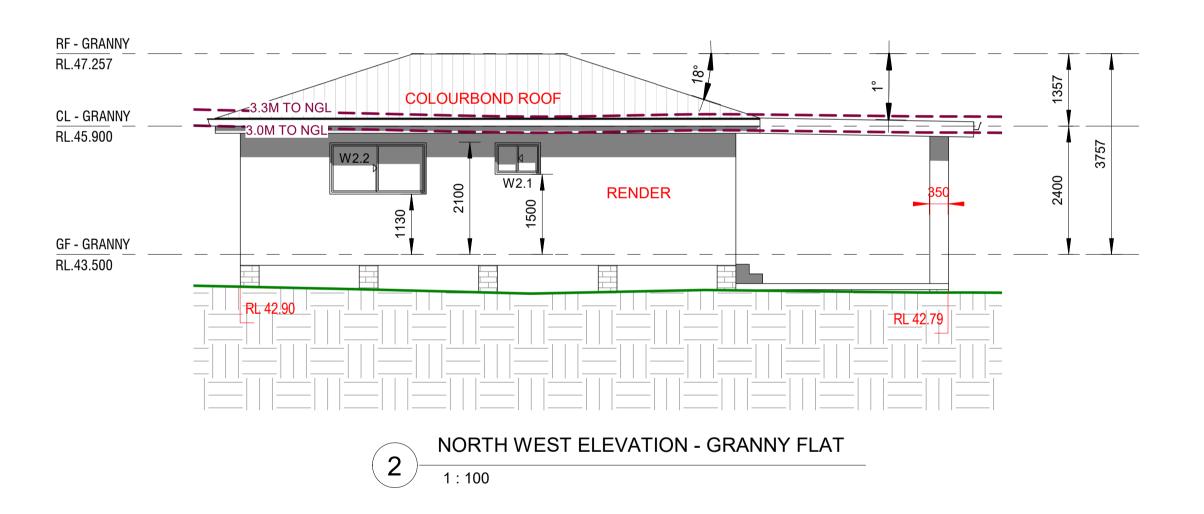
Design.

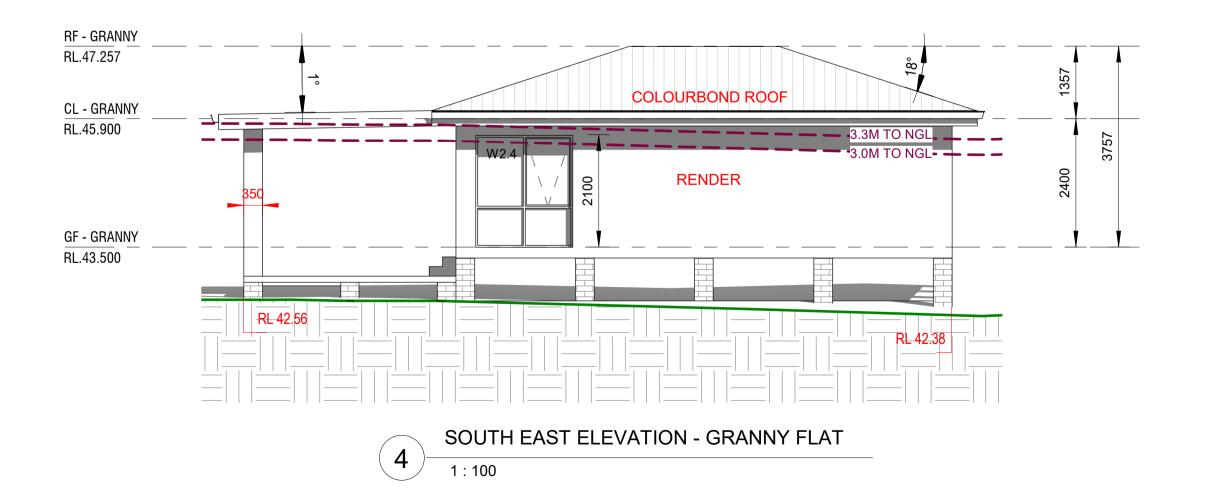


CHANGE FROM CONCRETE ROOF SLAB TO COLOURBOND ROOF **MODIFICATION TO SKYLIGHTS LOCATION**

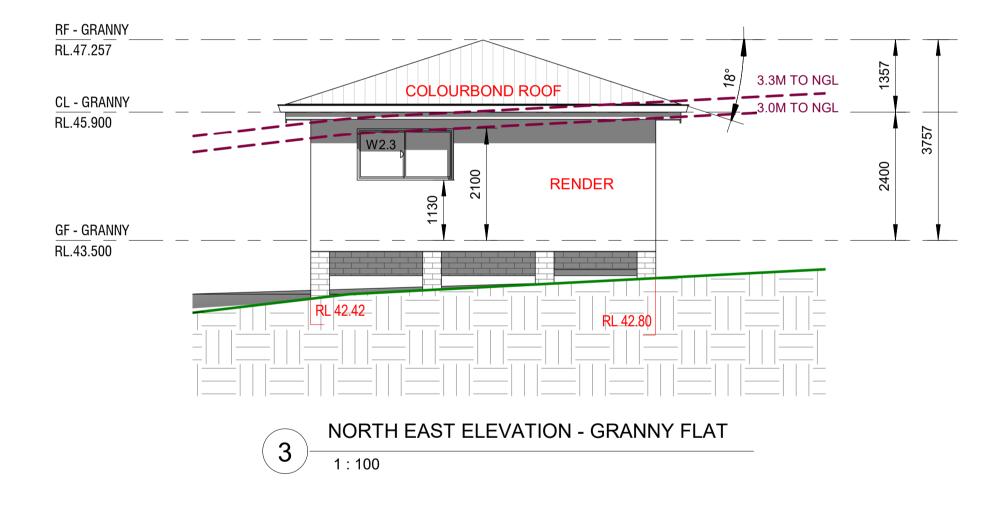
NKSTOWN.	PROPOSED TWO STOREY DWELLING WITH	JOB NUMBER:	DWG NUMBER:	ORIGINAL SIZE:
	BASEMENT, POOL & SECONDARY DWELLING	23611	A06.01	A2
2 606 228	45 HILLCREST AVE, GREENACRE	DESIGNED BY:	DATE:	
gn.com.au	LOT 1, DP 21703	A.N.	25.02.2025	
	ELEVATIONS - PART 1	DRAWN BY: A.N.	SCALE: AS SHOWN	

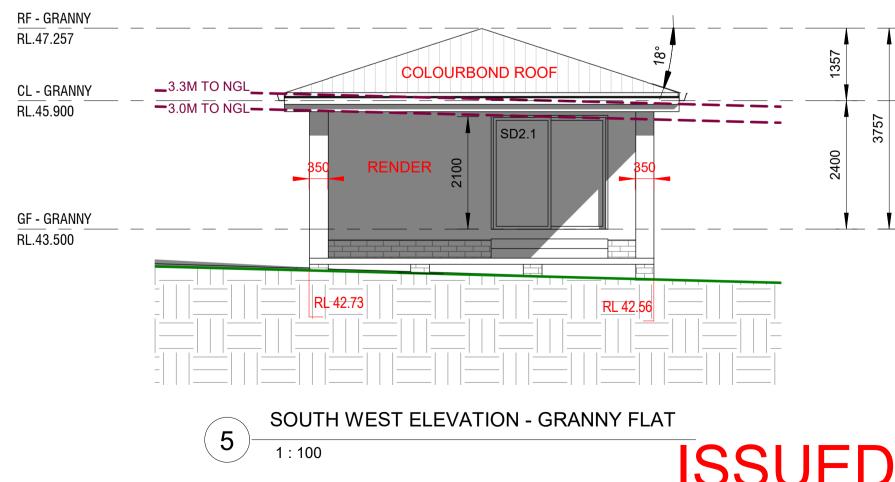


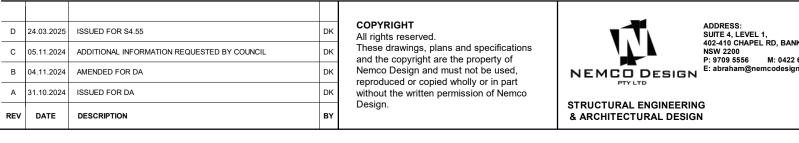




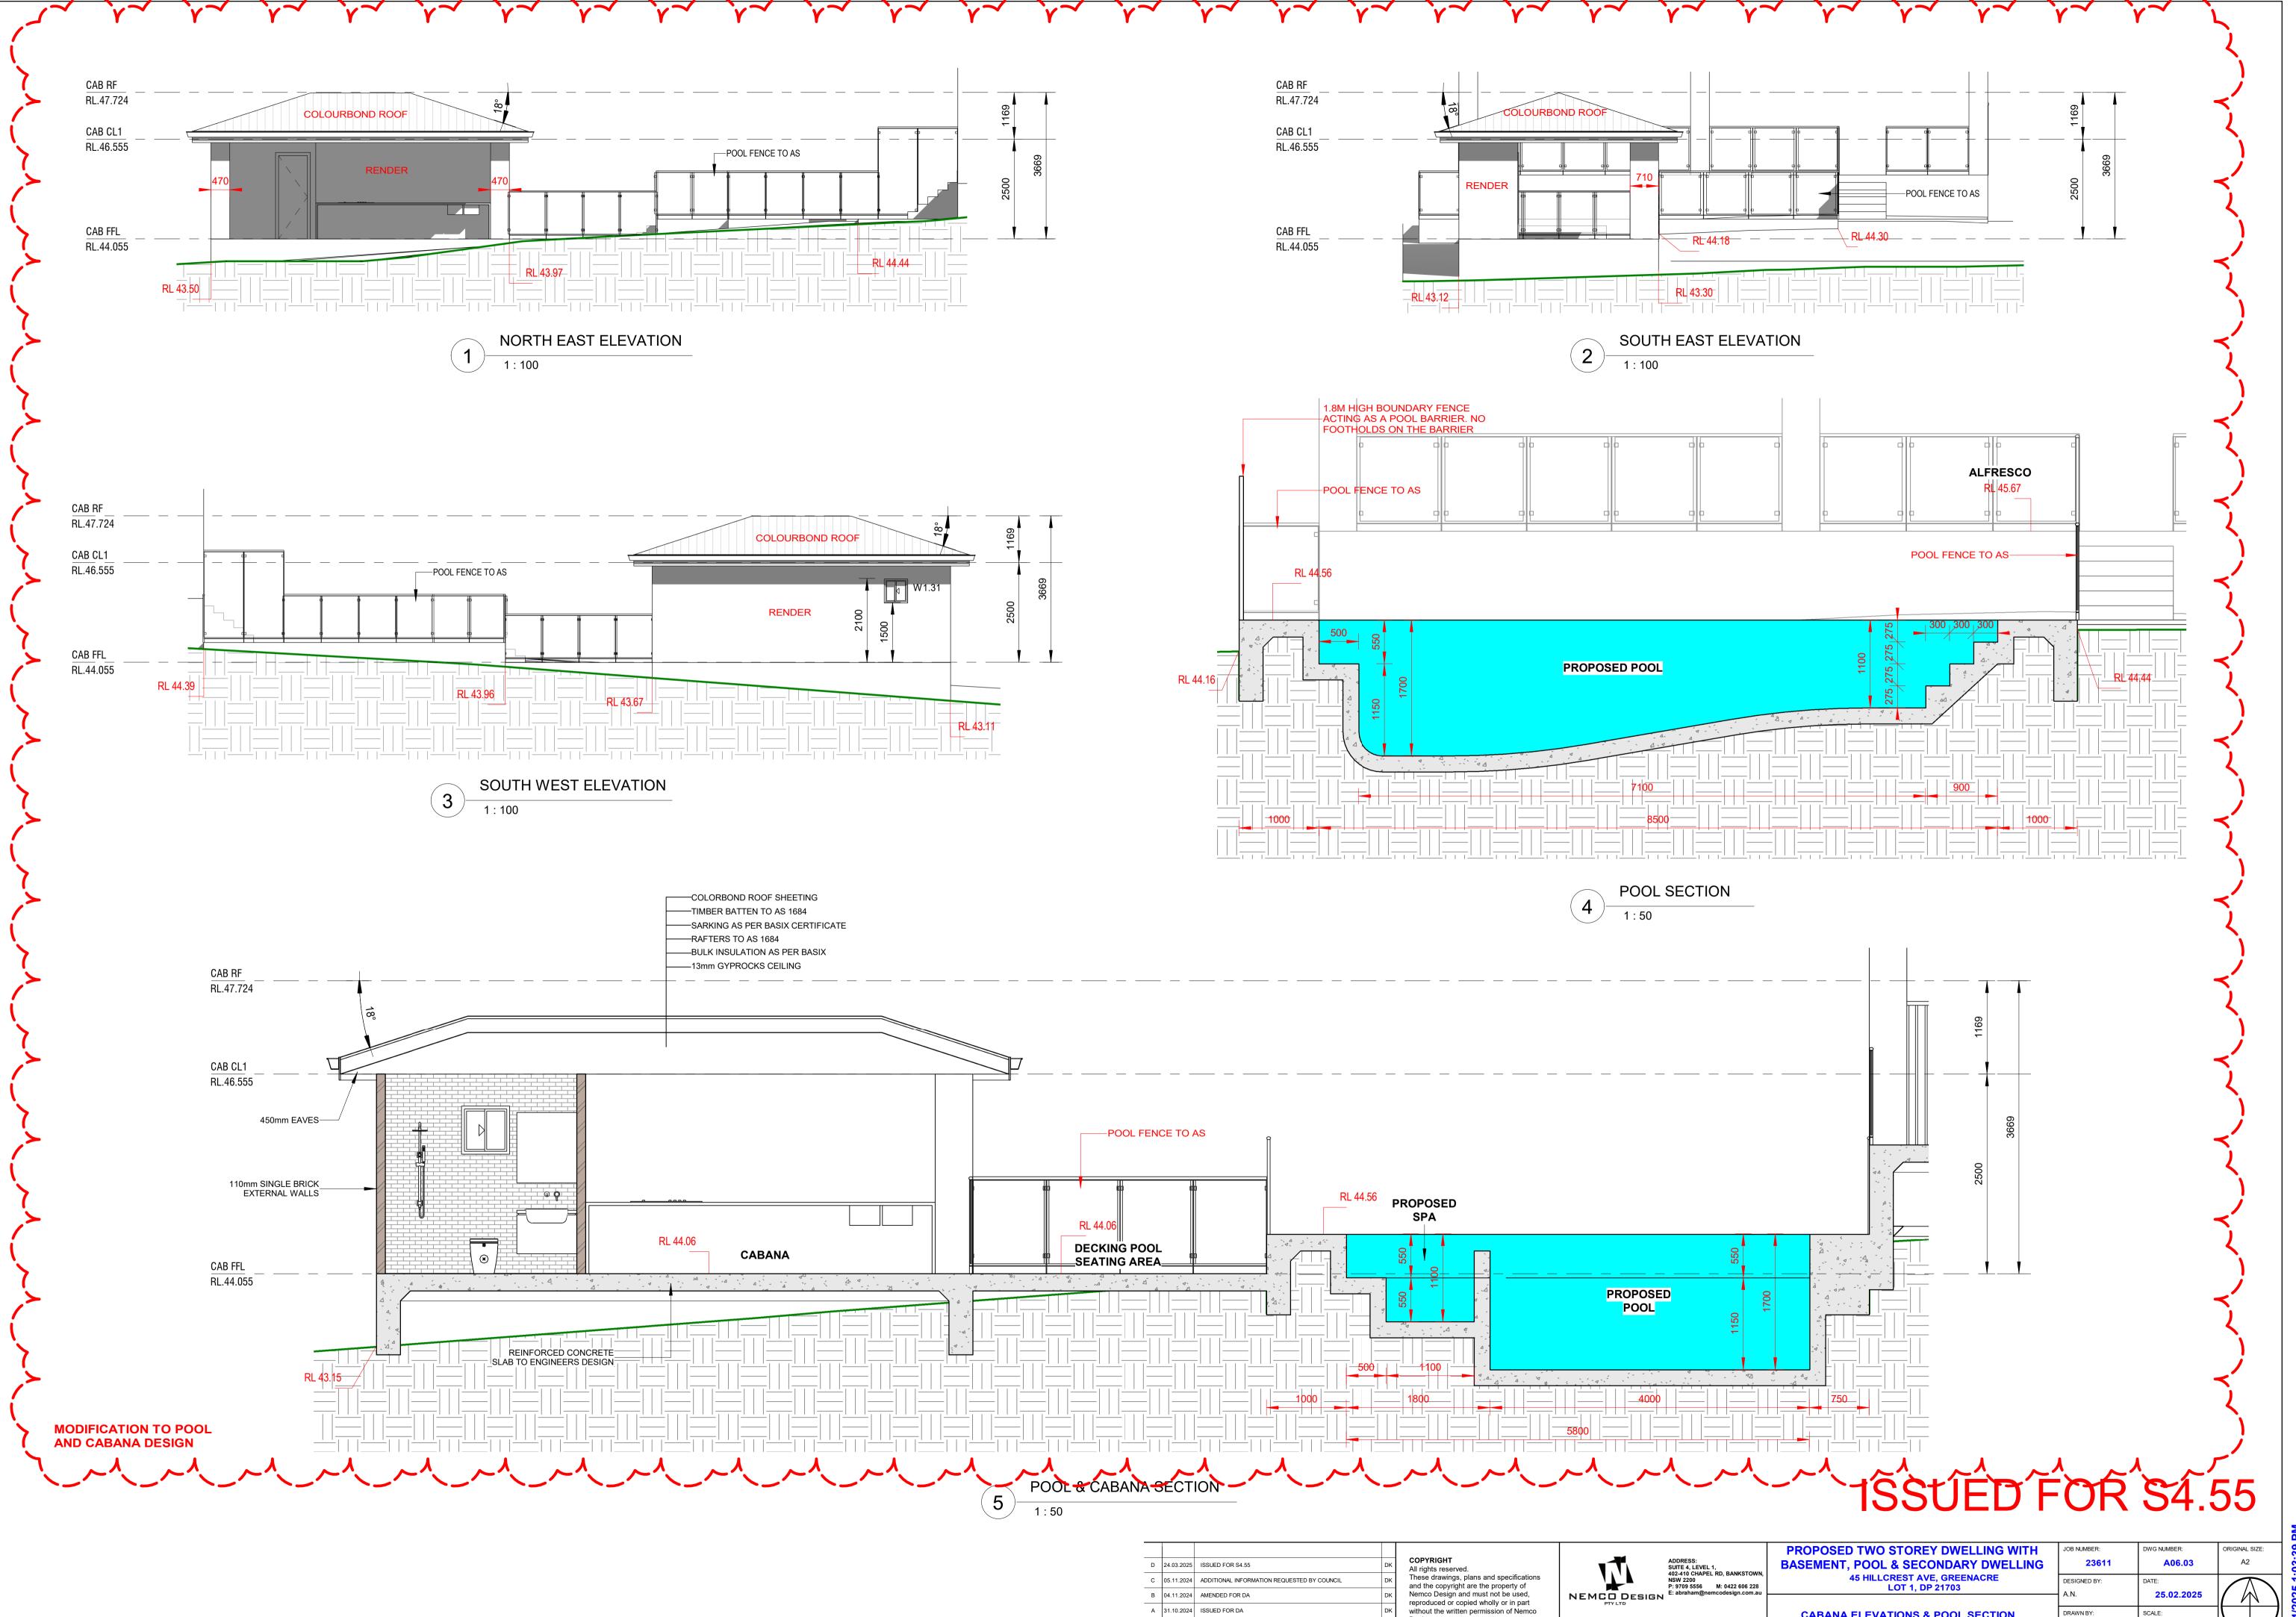
CHANGE FROM CONCRETE ROOF SLAB TO COLOURBOND ROOF **MODIFICATION TO SKYLIGHTS LOCATION**







BANKSTOWN, 0422 606 228 lesign.com.au	PROPOSED TWO STOREY DWELLING WITH BASEMENT, POOL & SECONDARY DWELLING	JOB NUMBER: 23611	DWG NUMBER: A06.02	ORIGINAL SIZE: A2
	45 HILLCREST AVE, GREENACRE LOT 1, DP 21703	DESIGNED BY: A.N.	DATE: 25.02.2025	
	ELEVATIONS - PART 2	DRAWN BY: SCALE: A.N. AS SHOWN		

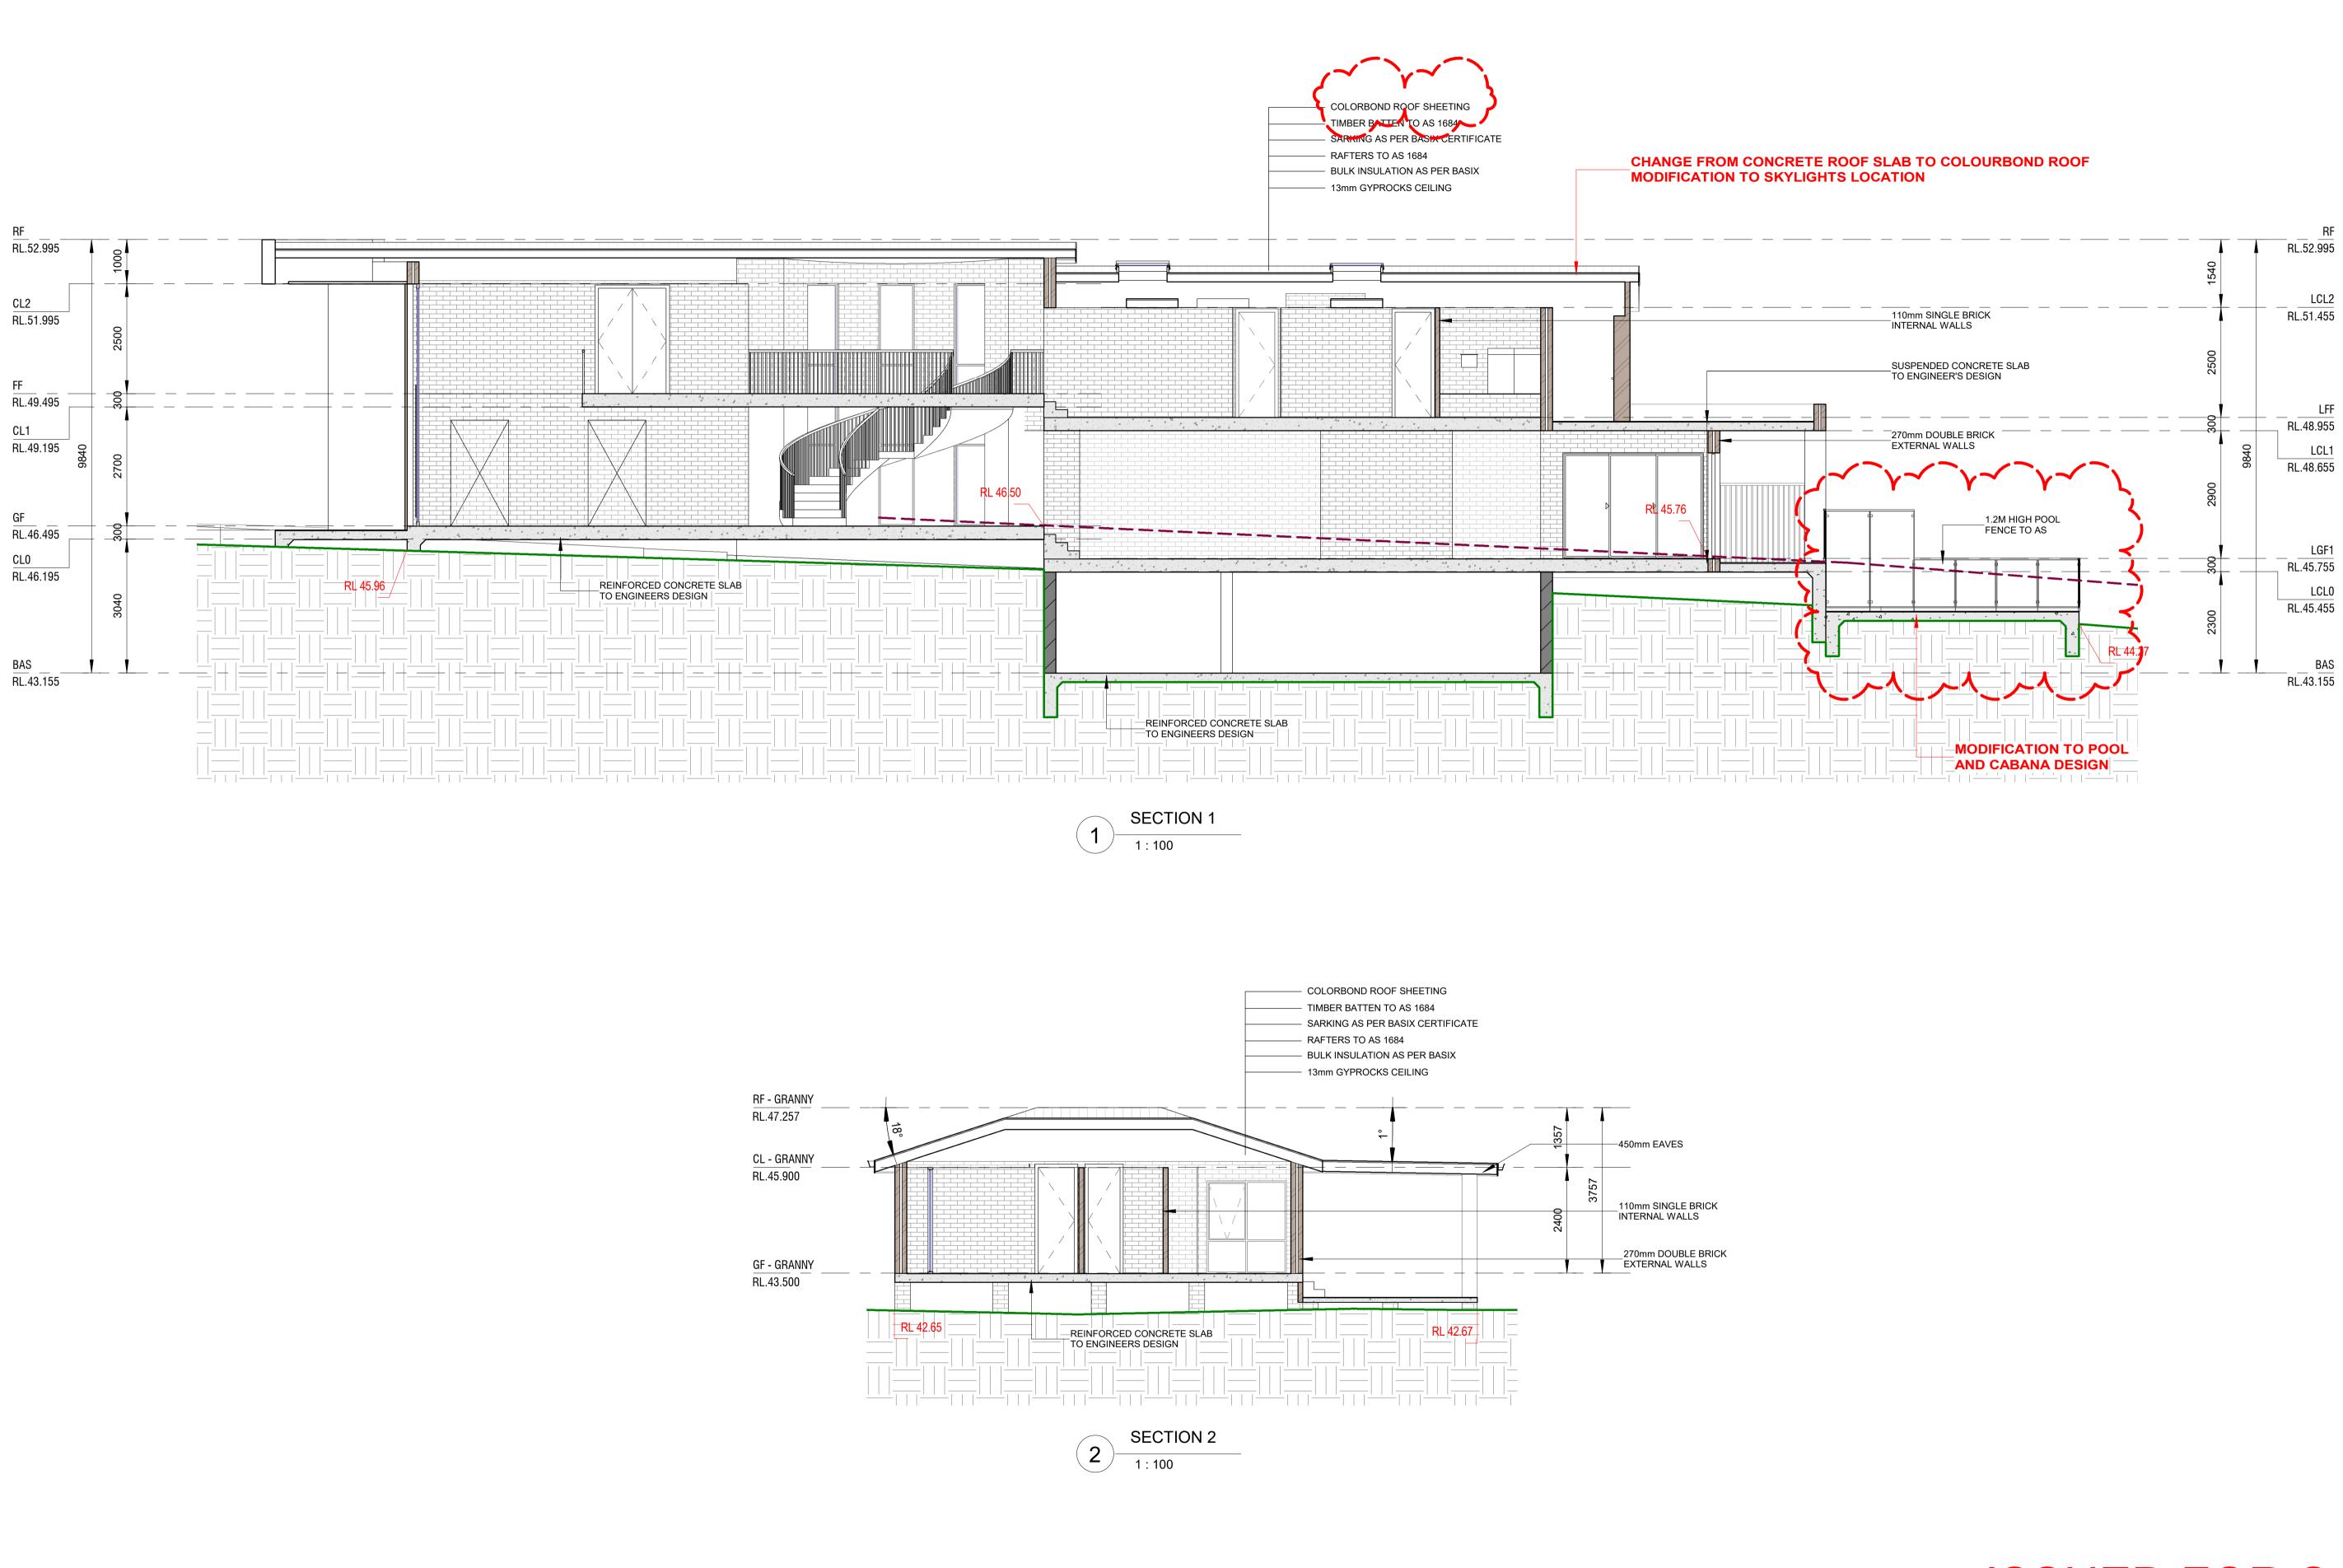


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AS SHOWN

A.N.

CABANA ELEVATIONS & POOL SECTION

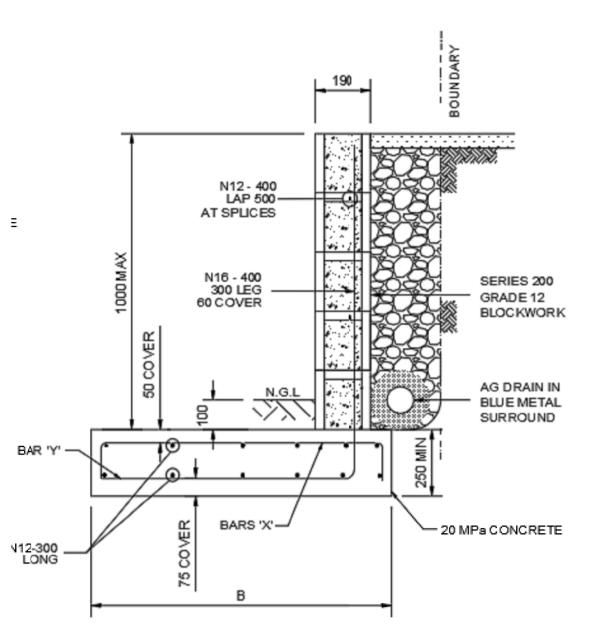


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STOWN.	PROPOSED TWO STOREY DWELLING WITH	JOB NUMBER:	DWG NUMBER:	ORIGINAL SIZE:
	BASEMENT, POOL & SECONDARY DWELLING	23611	A07	A2
06 228	45 HILLCREST AVE, GREENACRE	DESIGNED BY:	DATE:	
com.au	LOT 1, DP 21703	A.N.	25.02.2025	
	SECTION 1 & 2	drawn by: A.N.	SCALE: AS SHOWN	



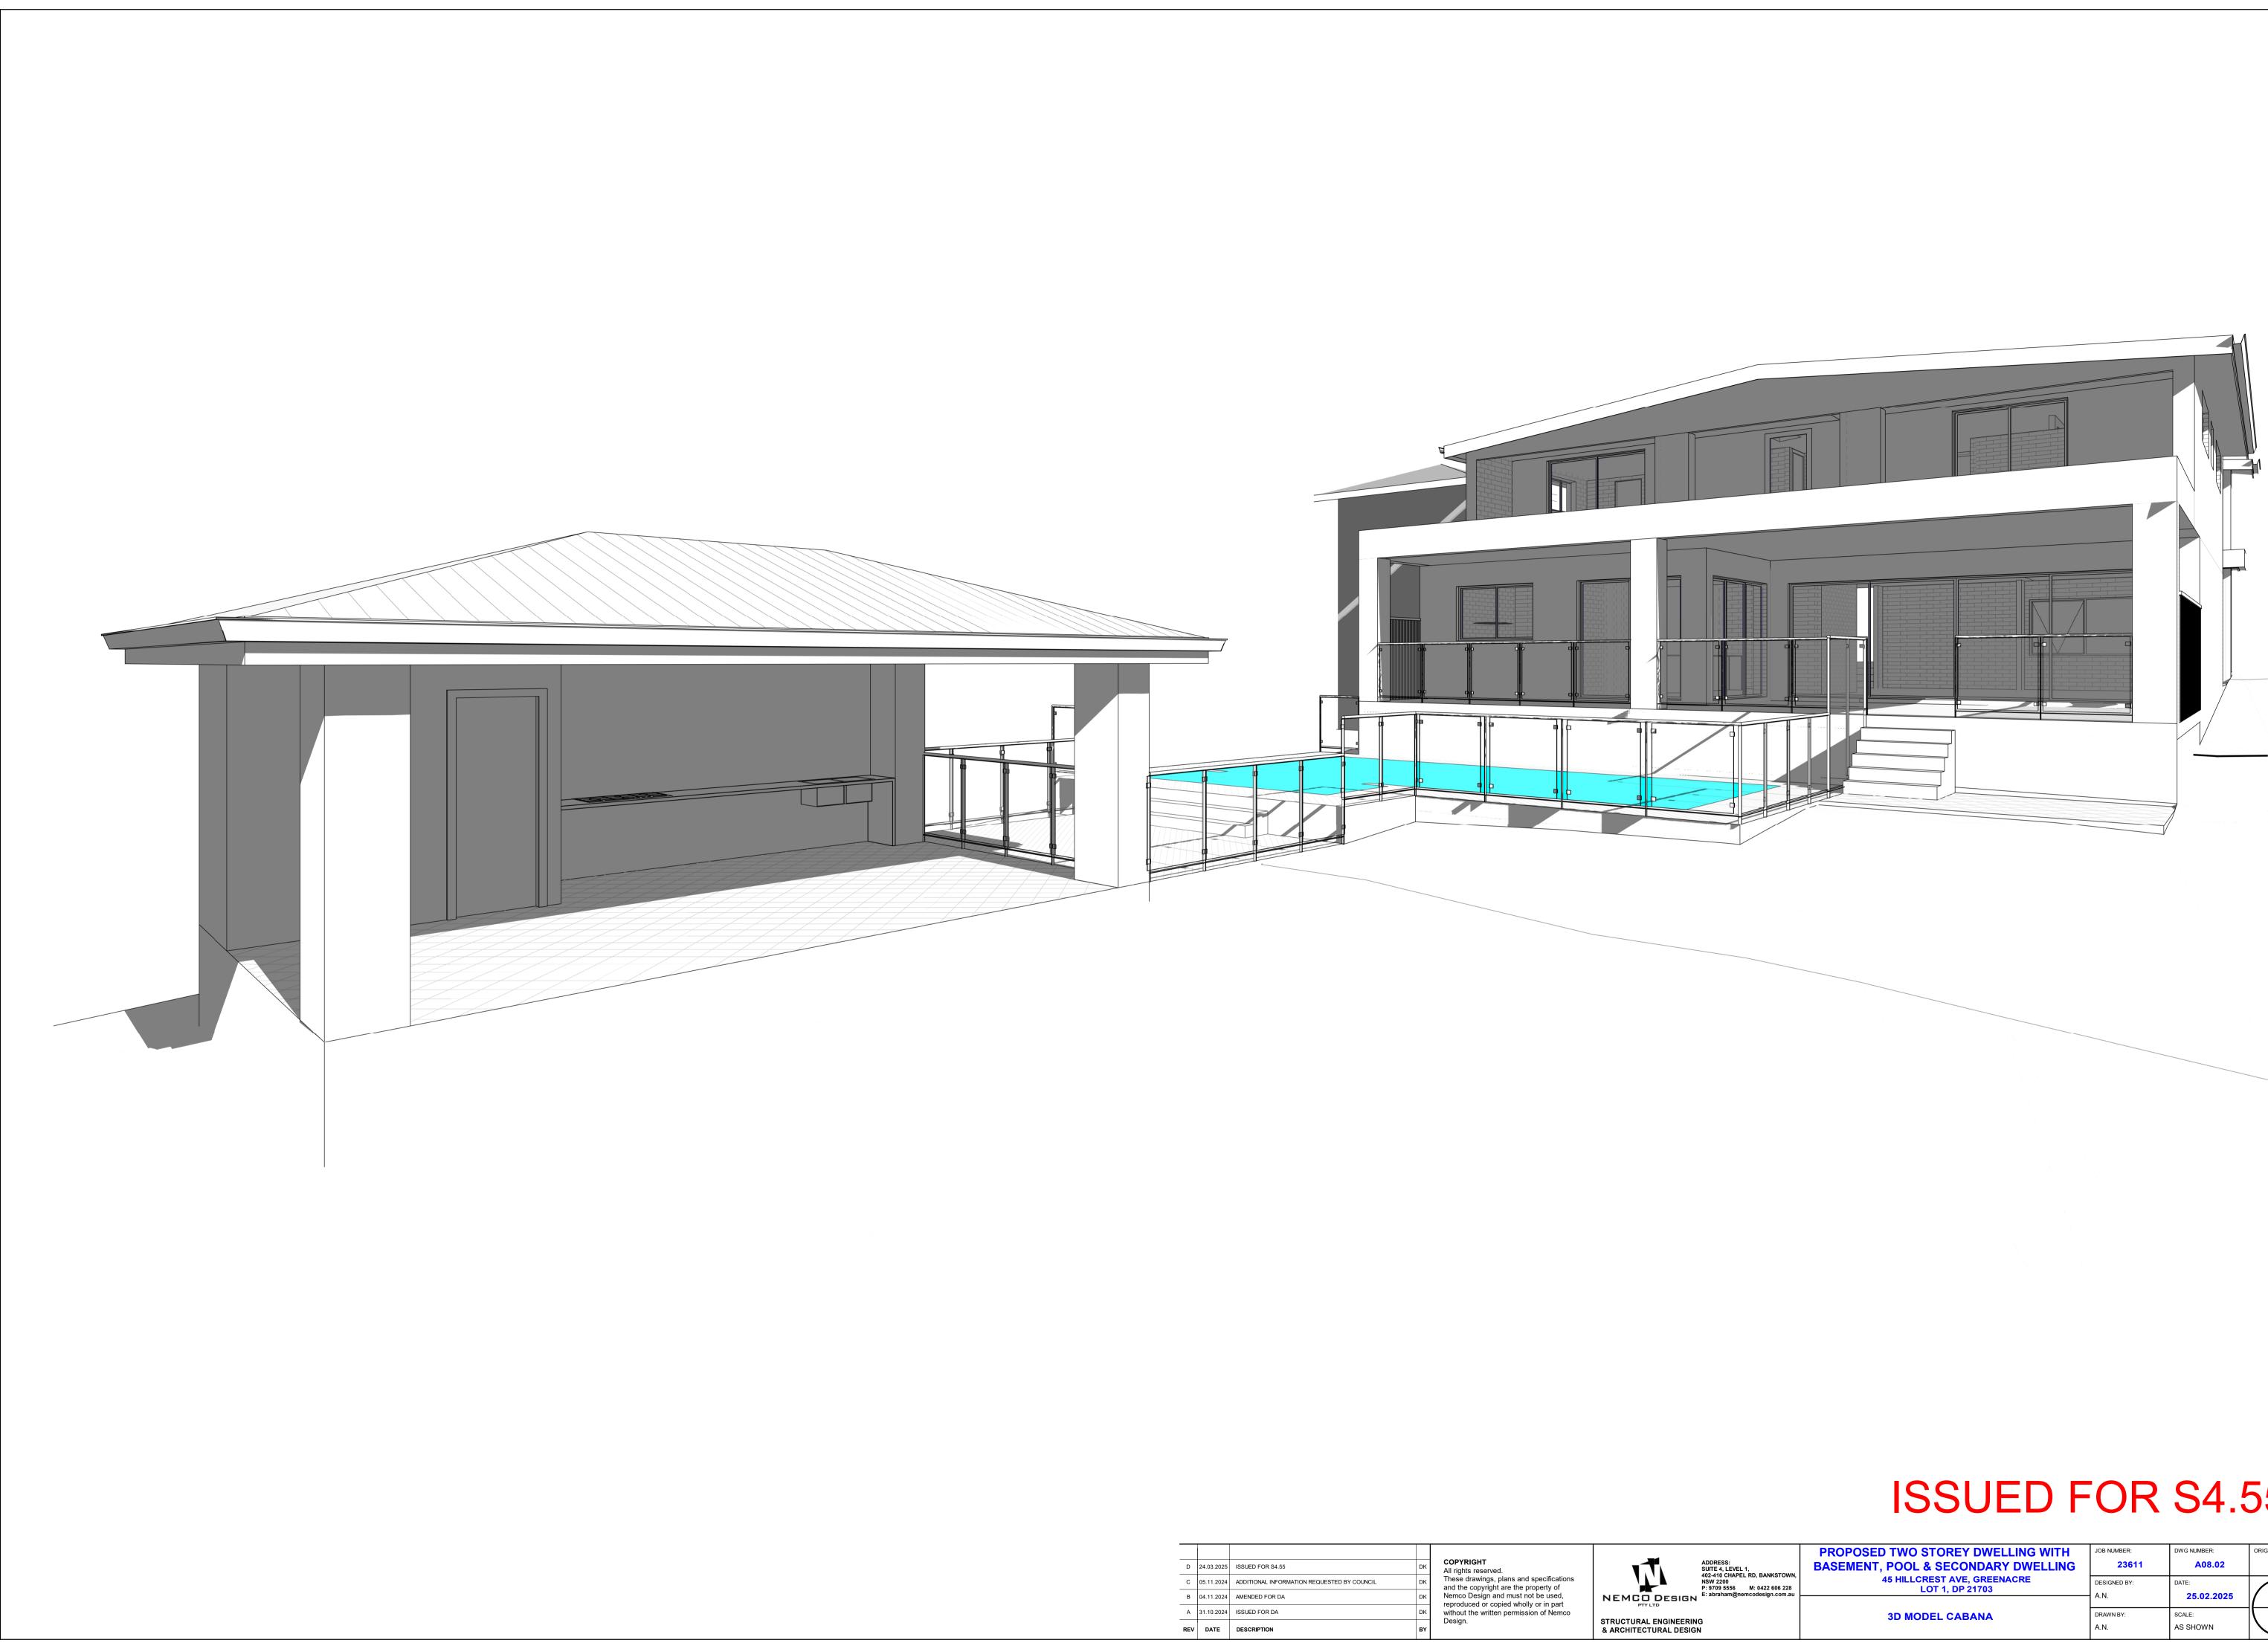
D	24.03.2025	ISSUED FOR S4.55	DK
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А	31.10.2024	ISSUED FOR DA	DK
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TYPICAL BLOCK RETAINING WALL DETAIL

ENSURE ALL STARTER BARS FOR WALLS ARE PLACED PRIOR TO POURING FOOTING

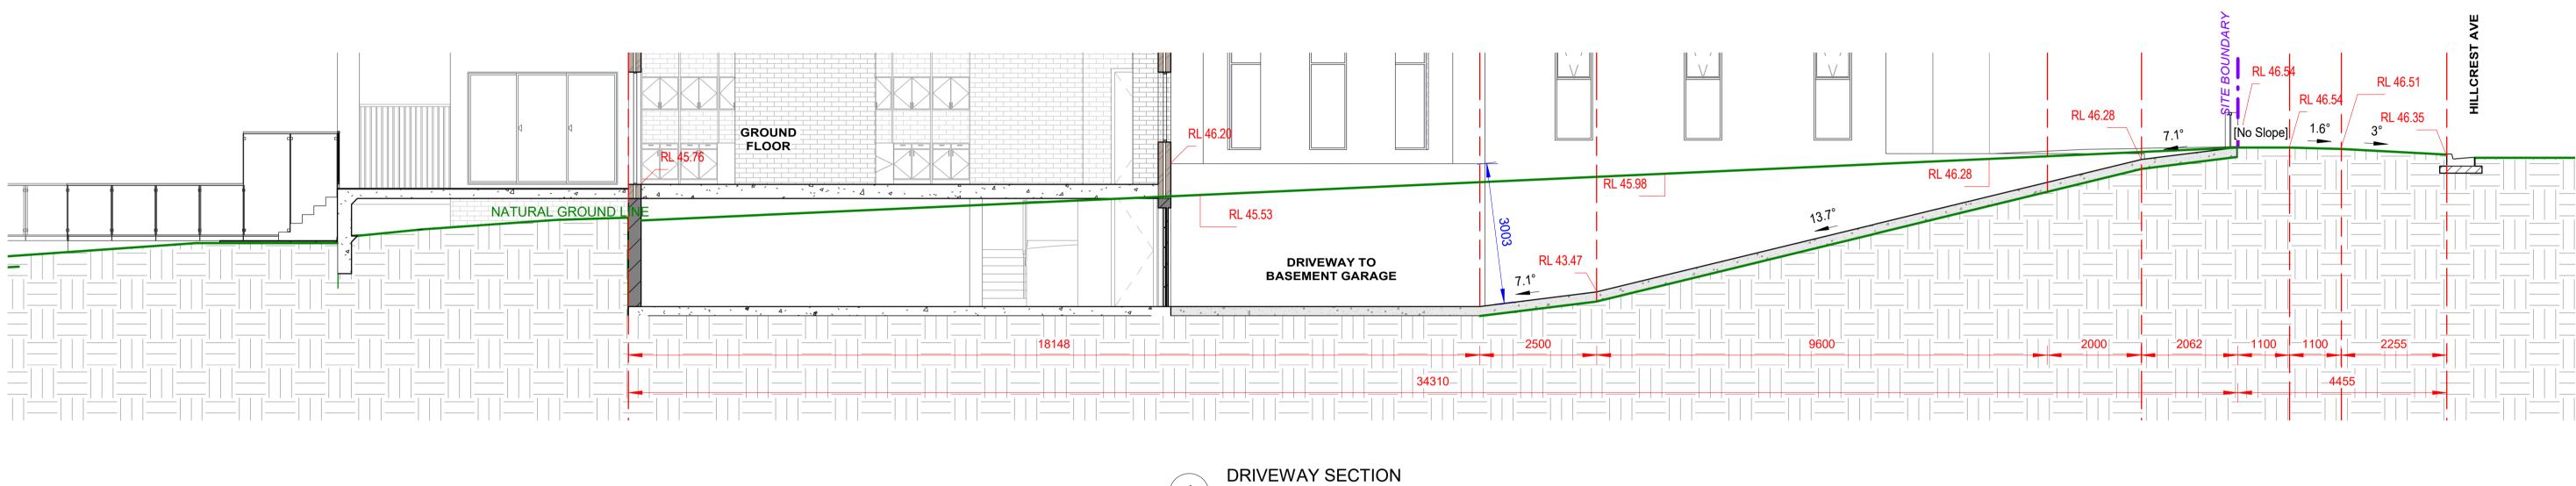
	PROPOSED TWO STOREY DWELLING WITH BASEMENT, POOL & SECONDARY DWELLING	JOB NUMBER: 23611	DWG NUMBER: A08.01	ORIGINAL SIZE: A2
(STOWN, 606 228 .com.au	45 HILLCREST AVE, GREENACRE LOT 1, DP 21703	DESIGNED BY:	DATE: 25.02.2025	
	PROPOSED RETAINING WALL & CUT & FILL PLAN	DRAWN BY: A.N.	SCALE: AS SHOWN	



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REV	DATE	DESCRIPTION	I
А	31.10.2024	ISSUED FOR DA	1
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С	05.11.2024	ADDITIONAL INFORMATION REQUESTED BY COUNCIL	1
D	24.03.2025	ISSUED FOR S4.55	

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	PROPOSED TWO STOREY DWELLING WITH BASEMENT, POOL & SECONDARY DWELLING	JOB NUMBER: 23611	DWG NUMBER: A08.02	ORIGINAL SIZE: A2
TOWN, 6 228 om.au	45 HILLCREST AVE, GREENACRE LOT 1, DP 21703	DESIGNED BY: A.N.	DATE: 25.02.2025	
	3D MODEL CABANA	DRAWN BY: A.N.	SCALE: AS SHOWN	



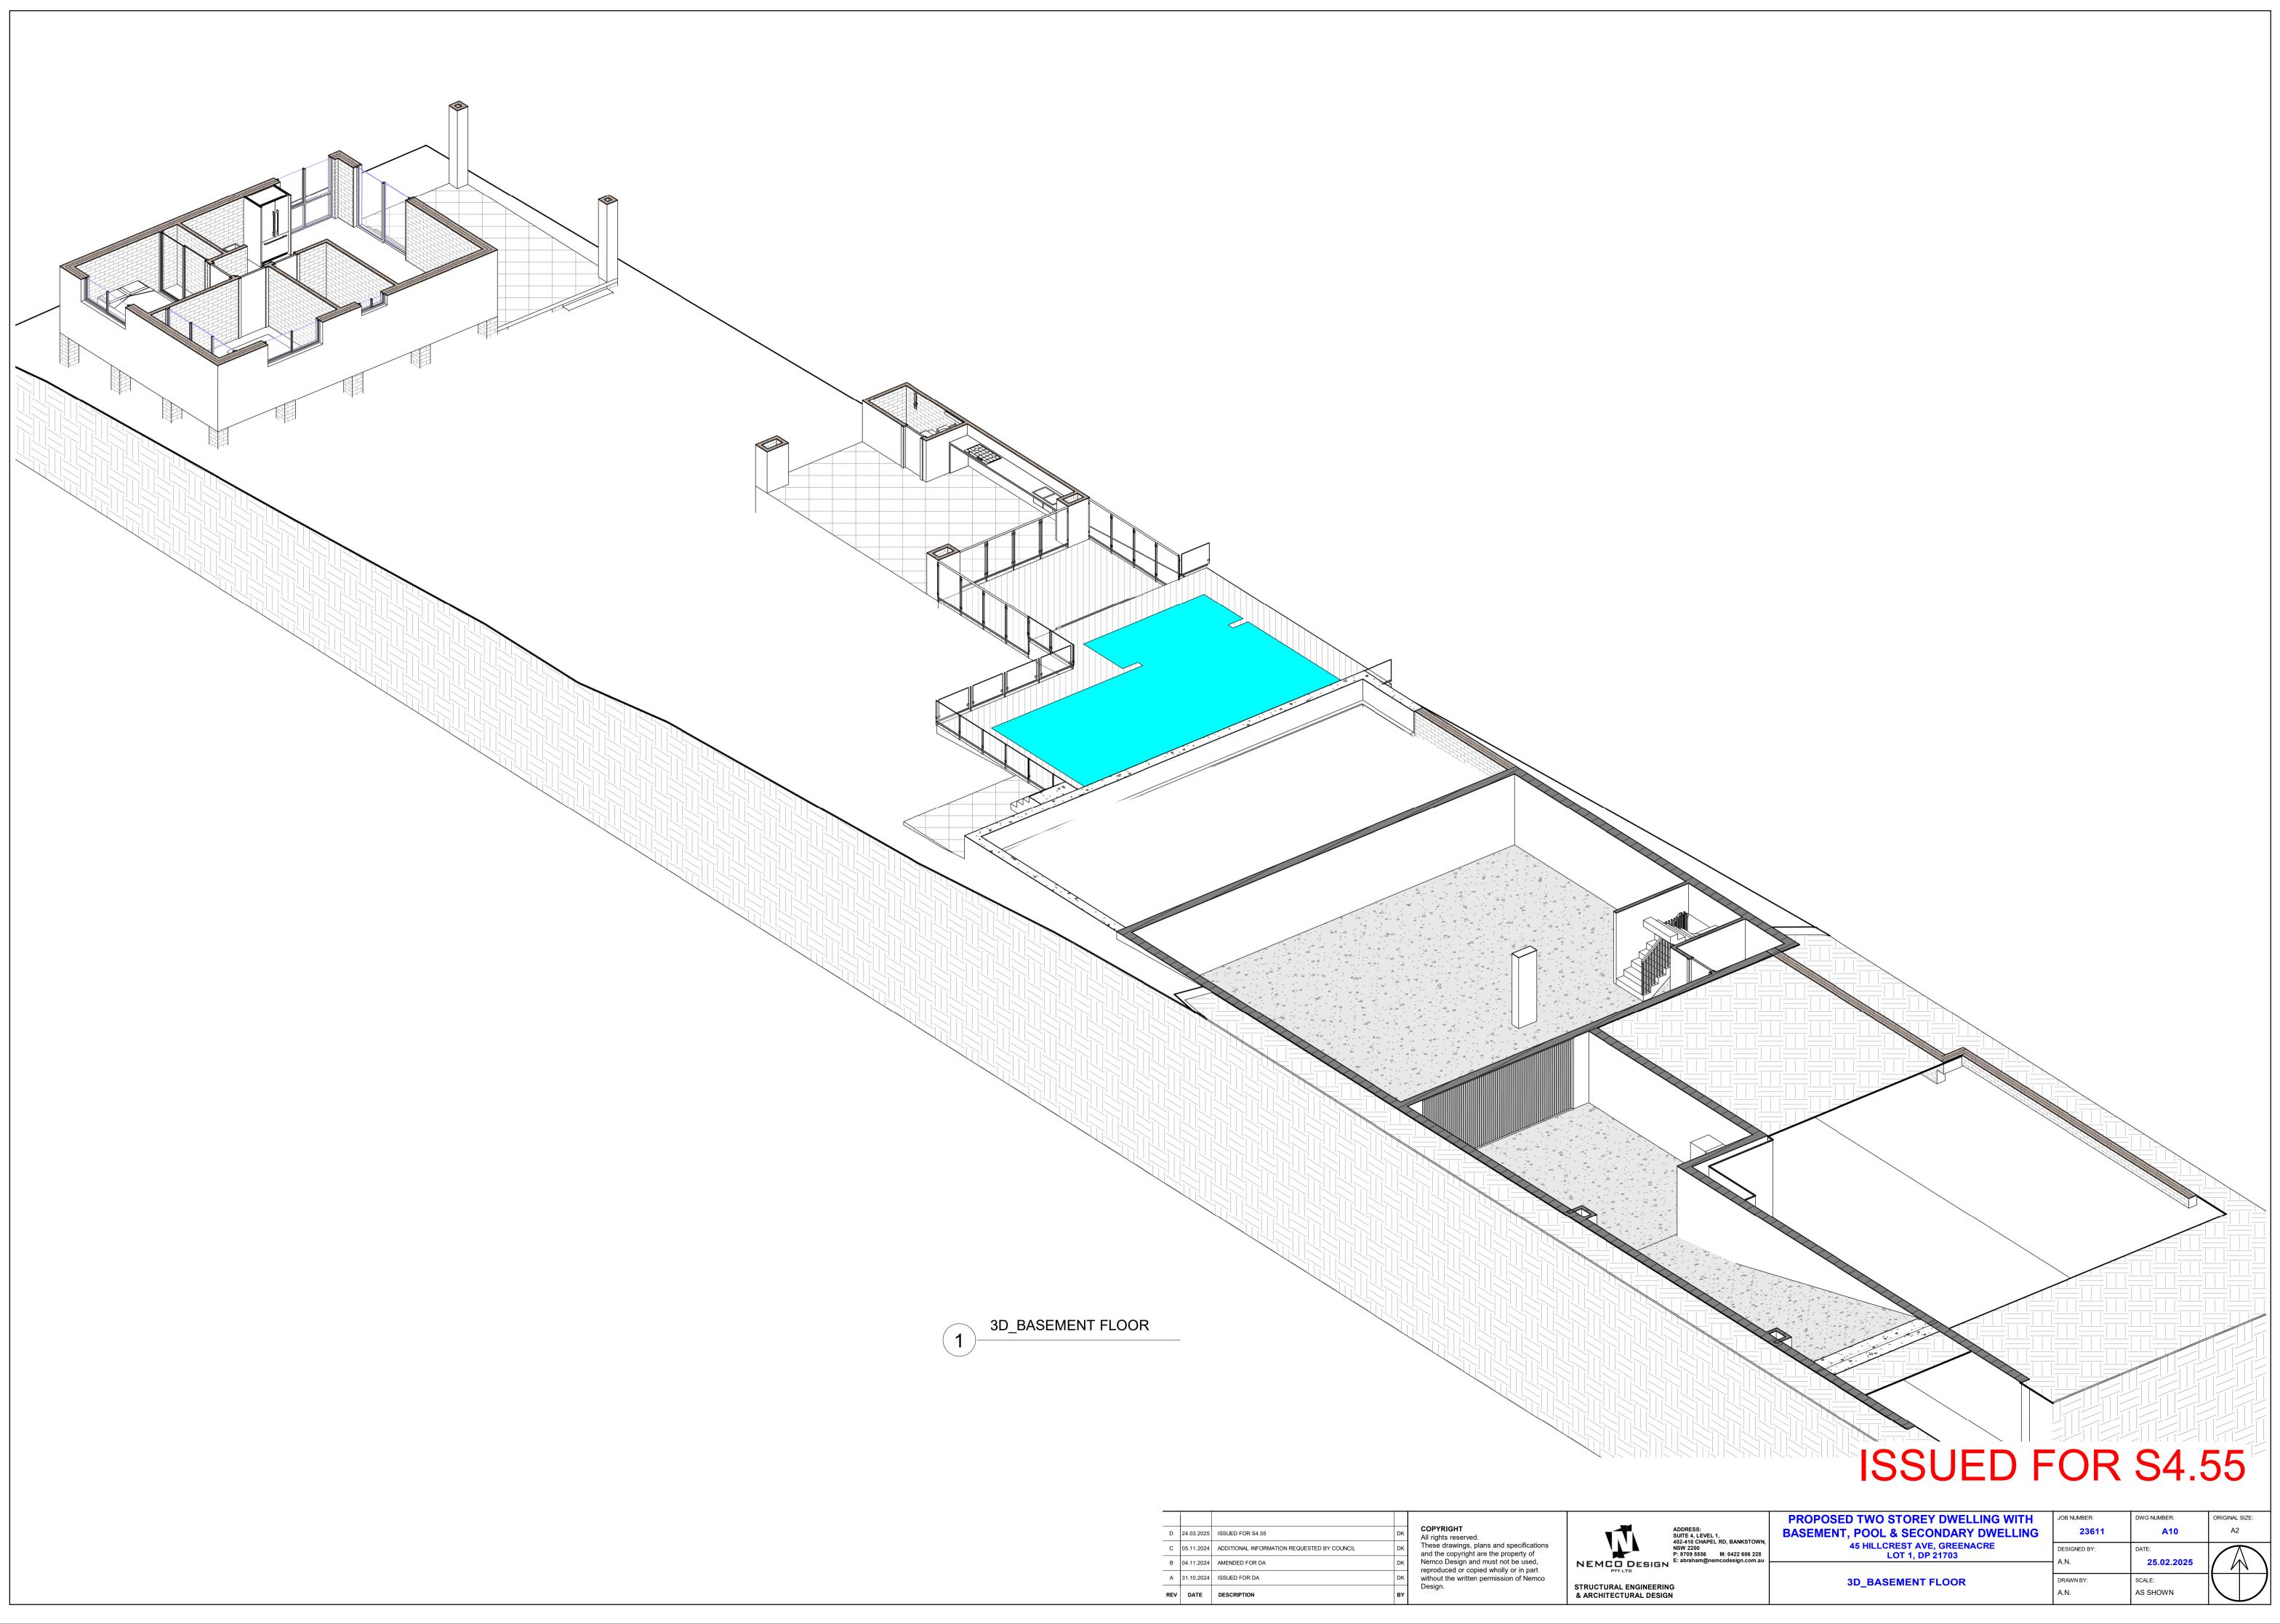
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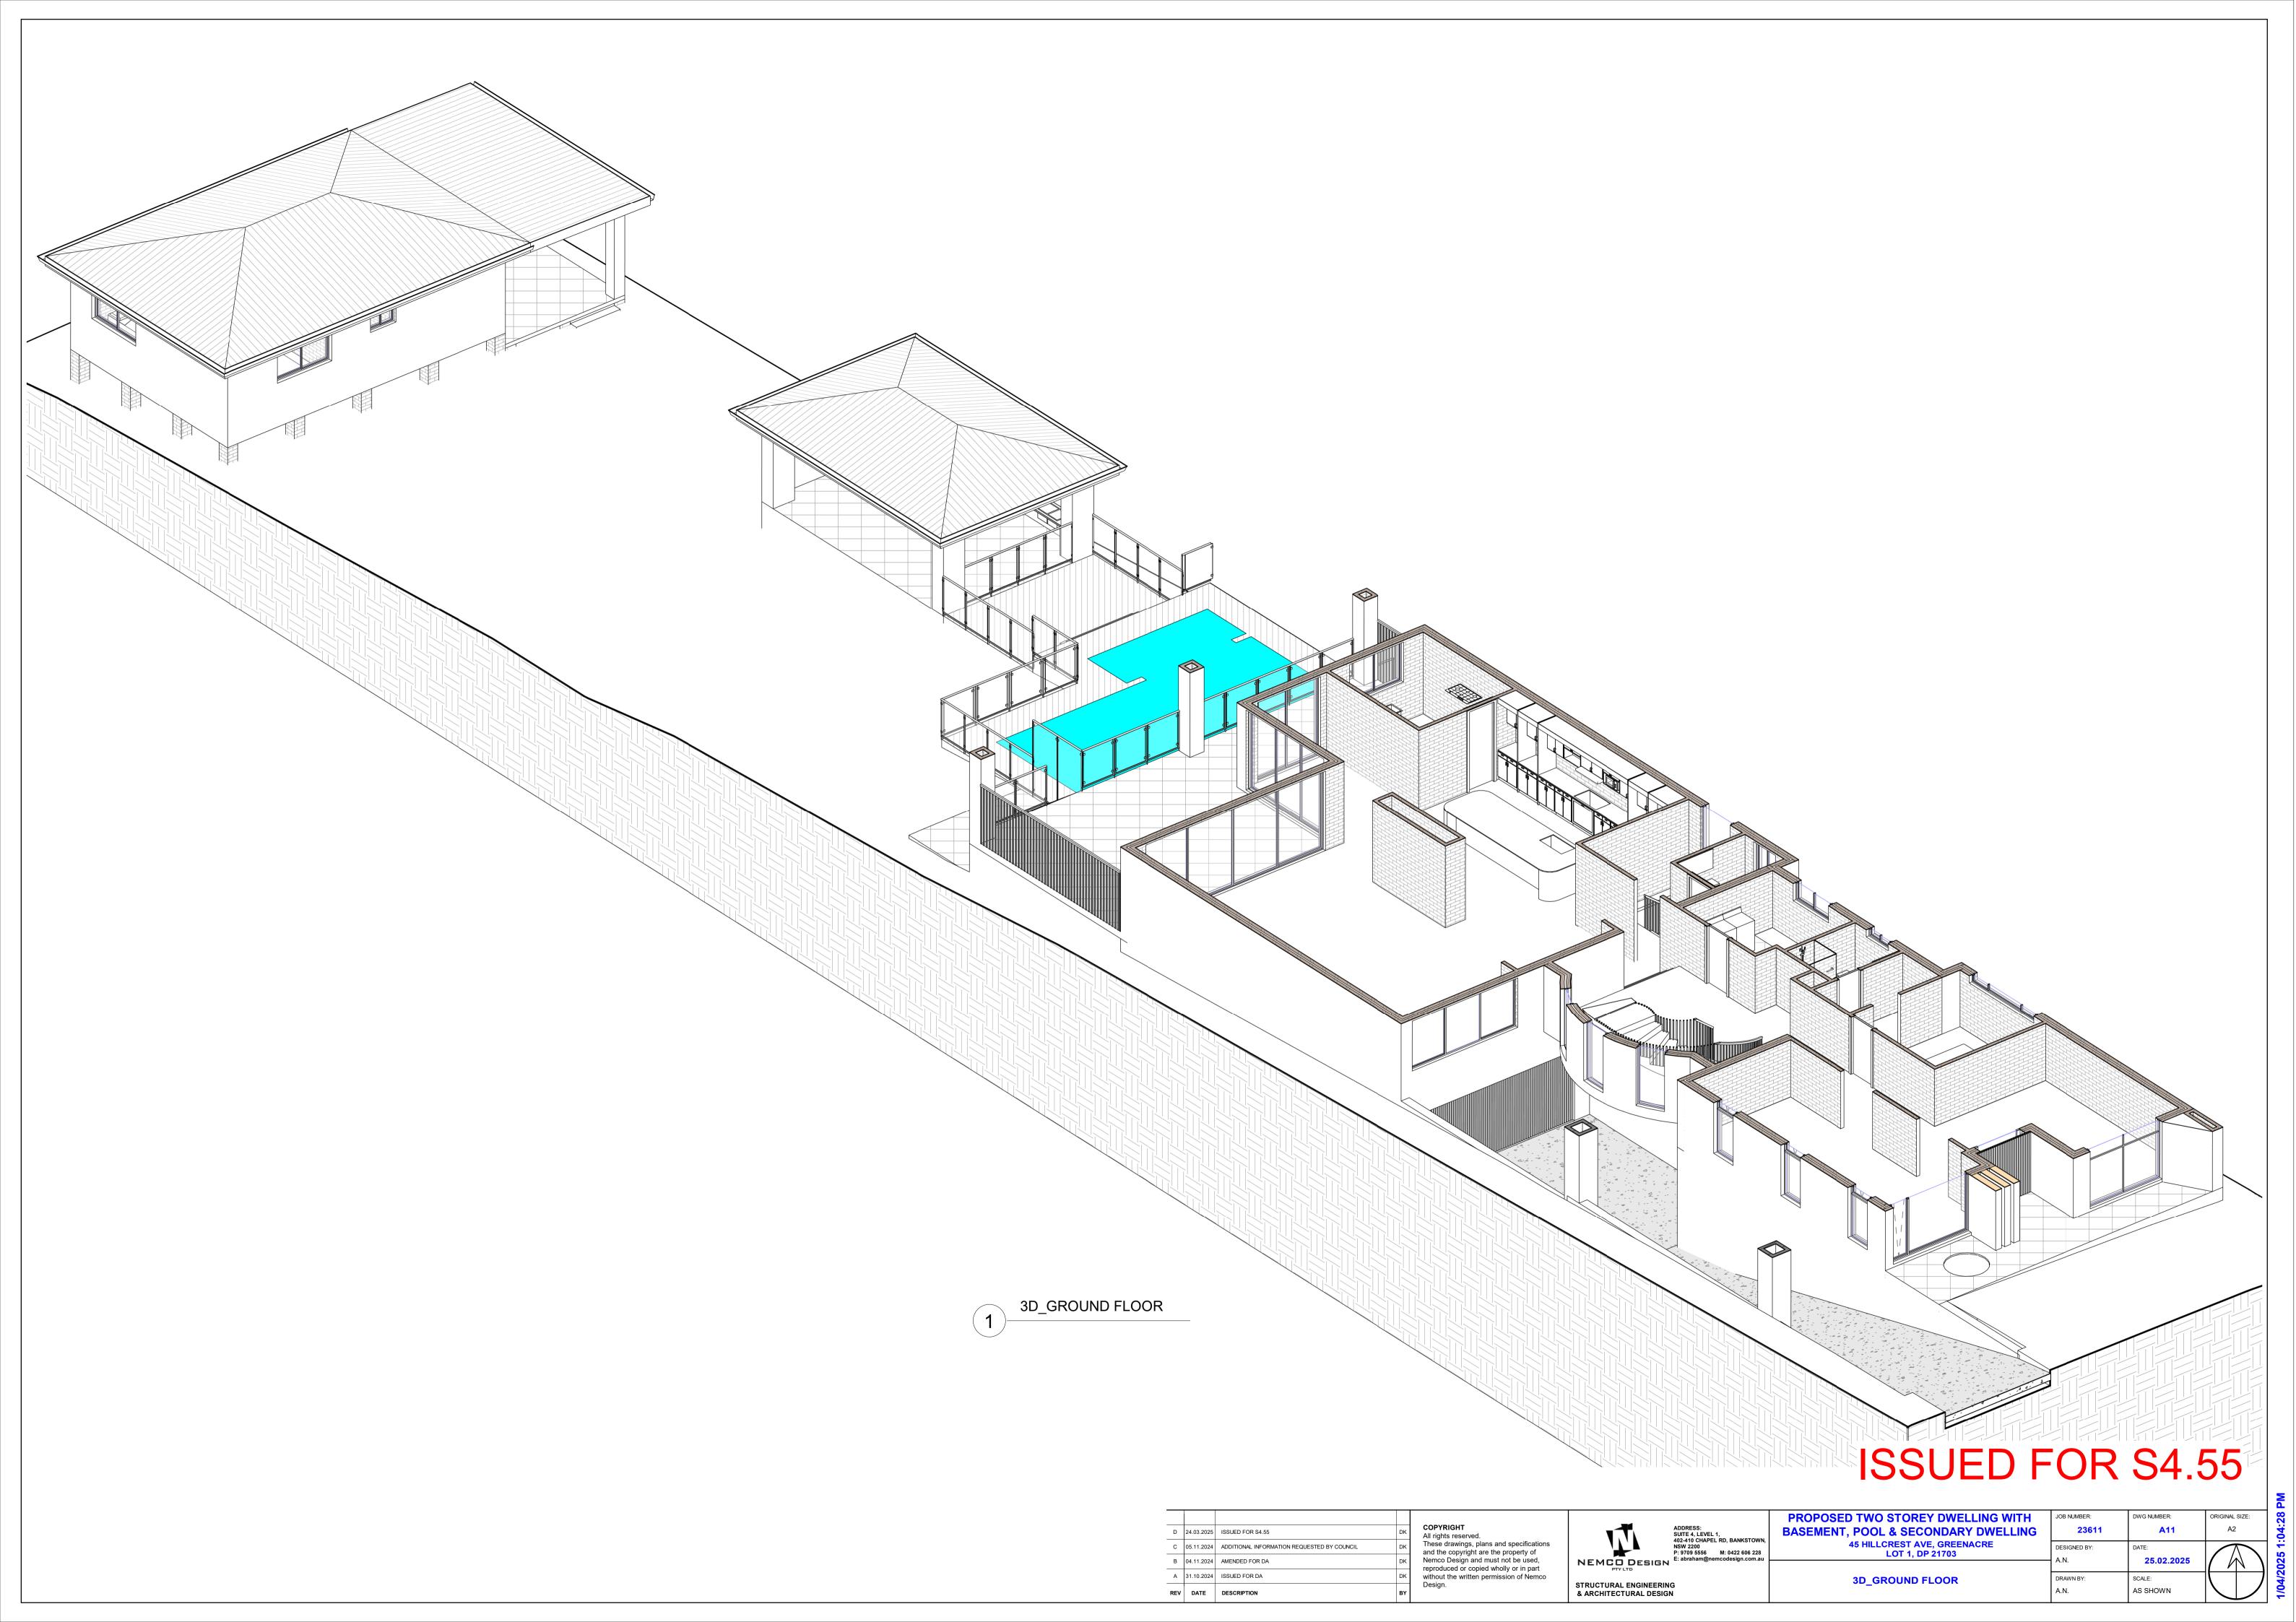
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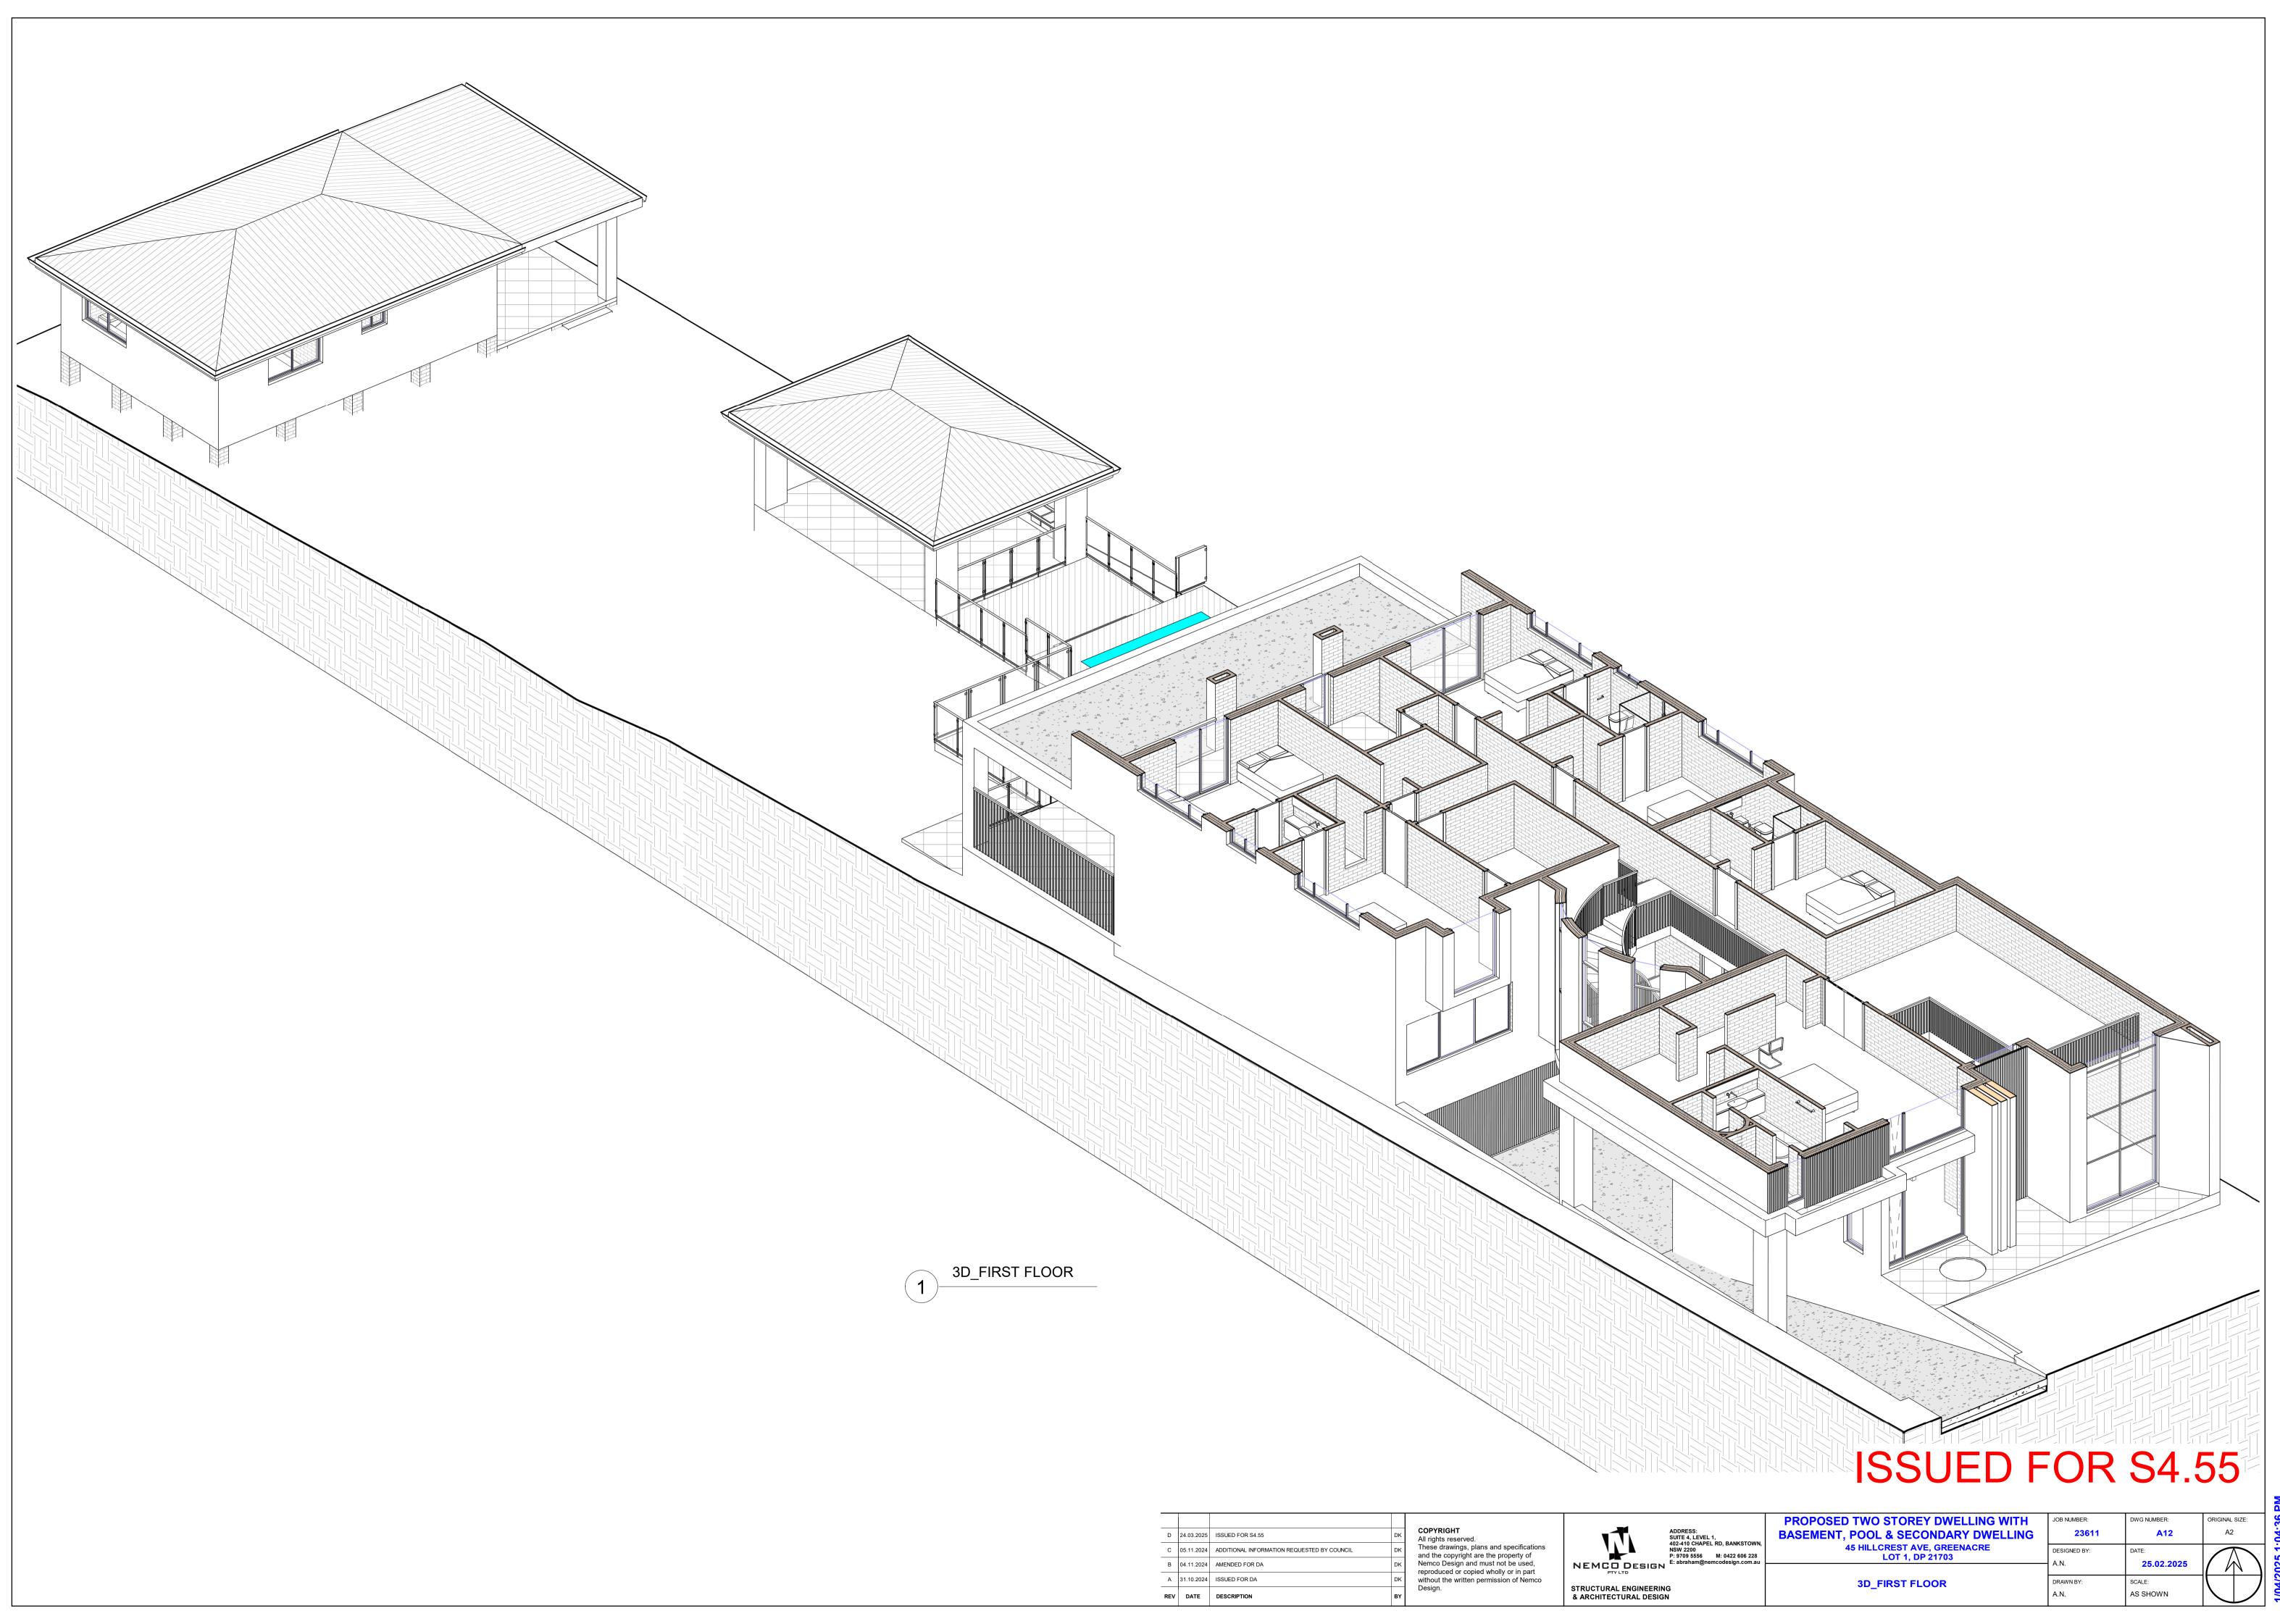


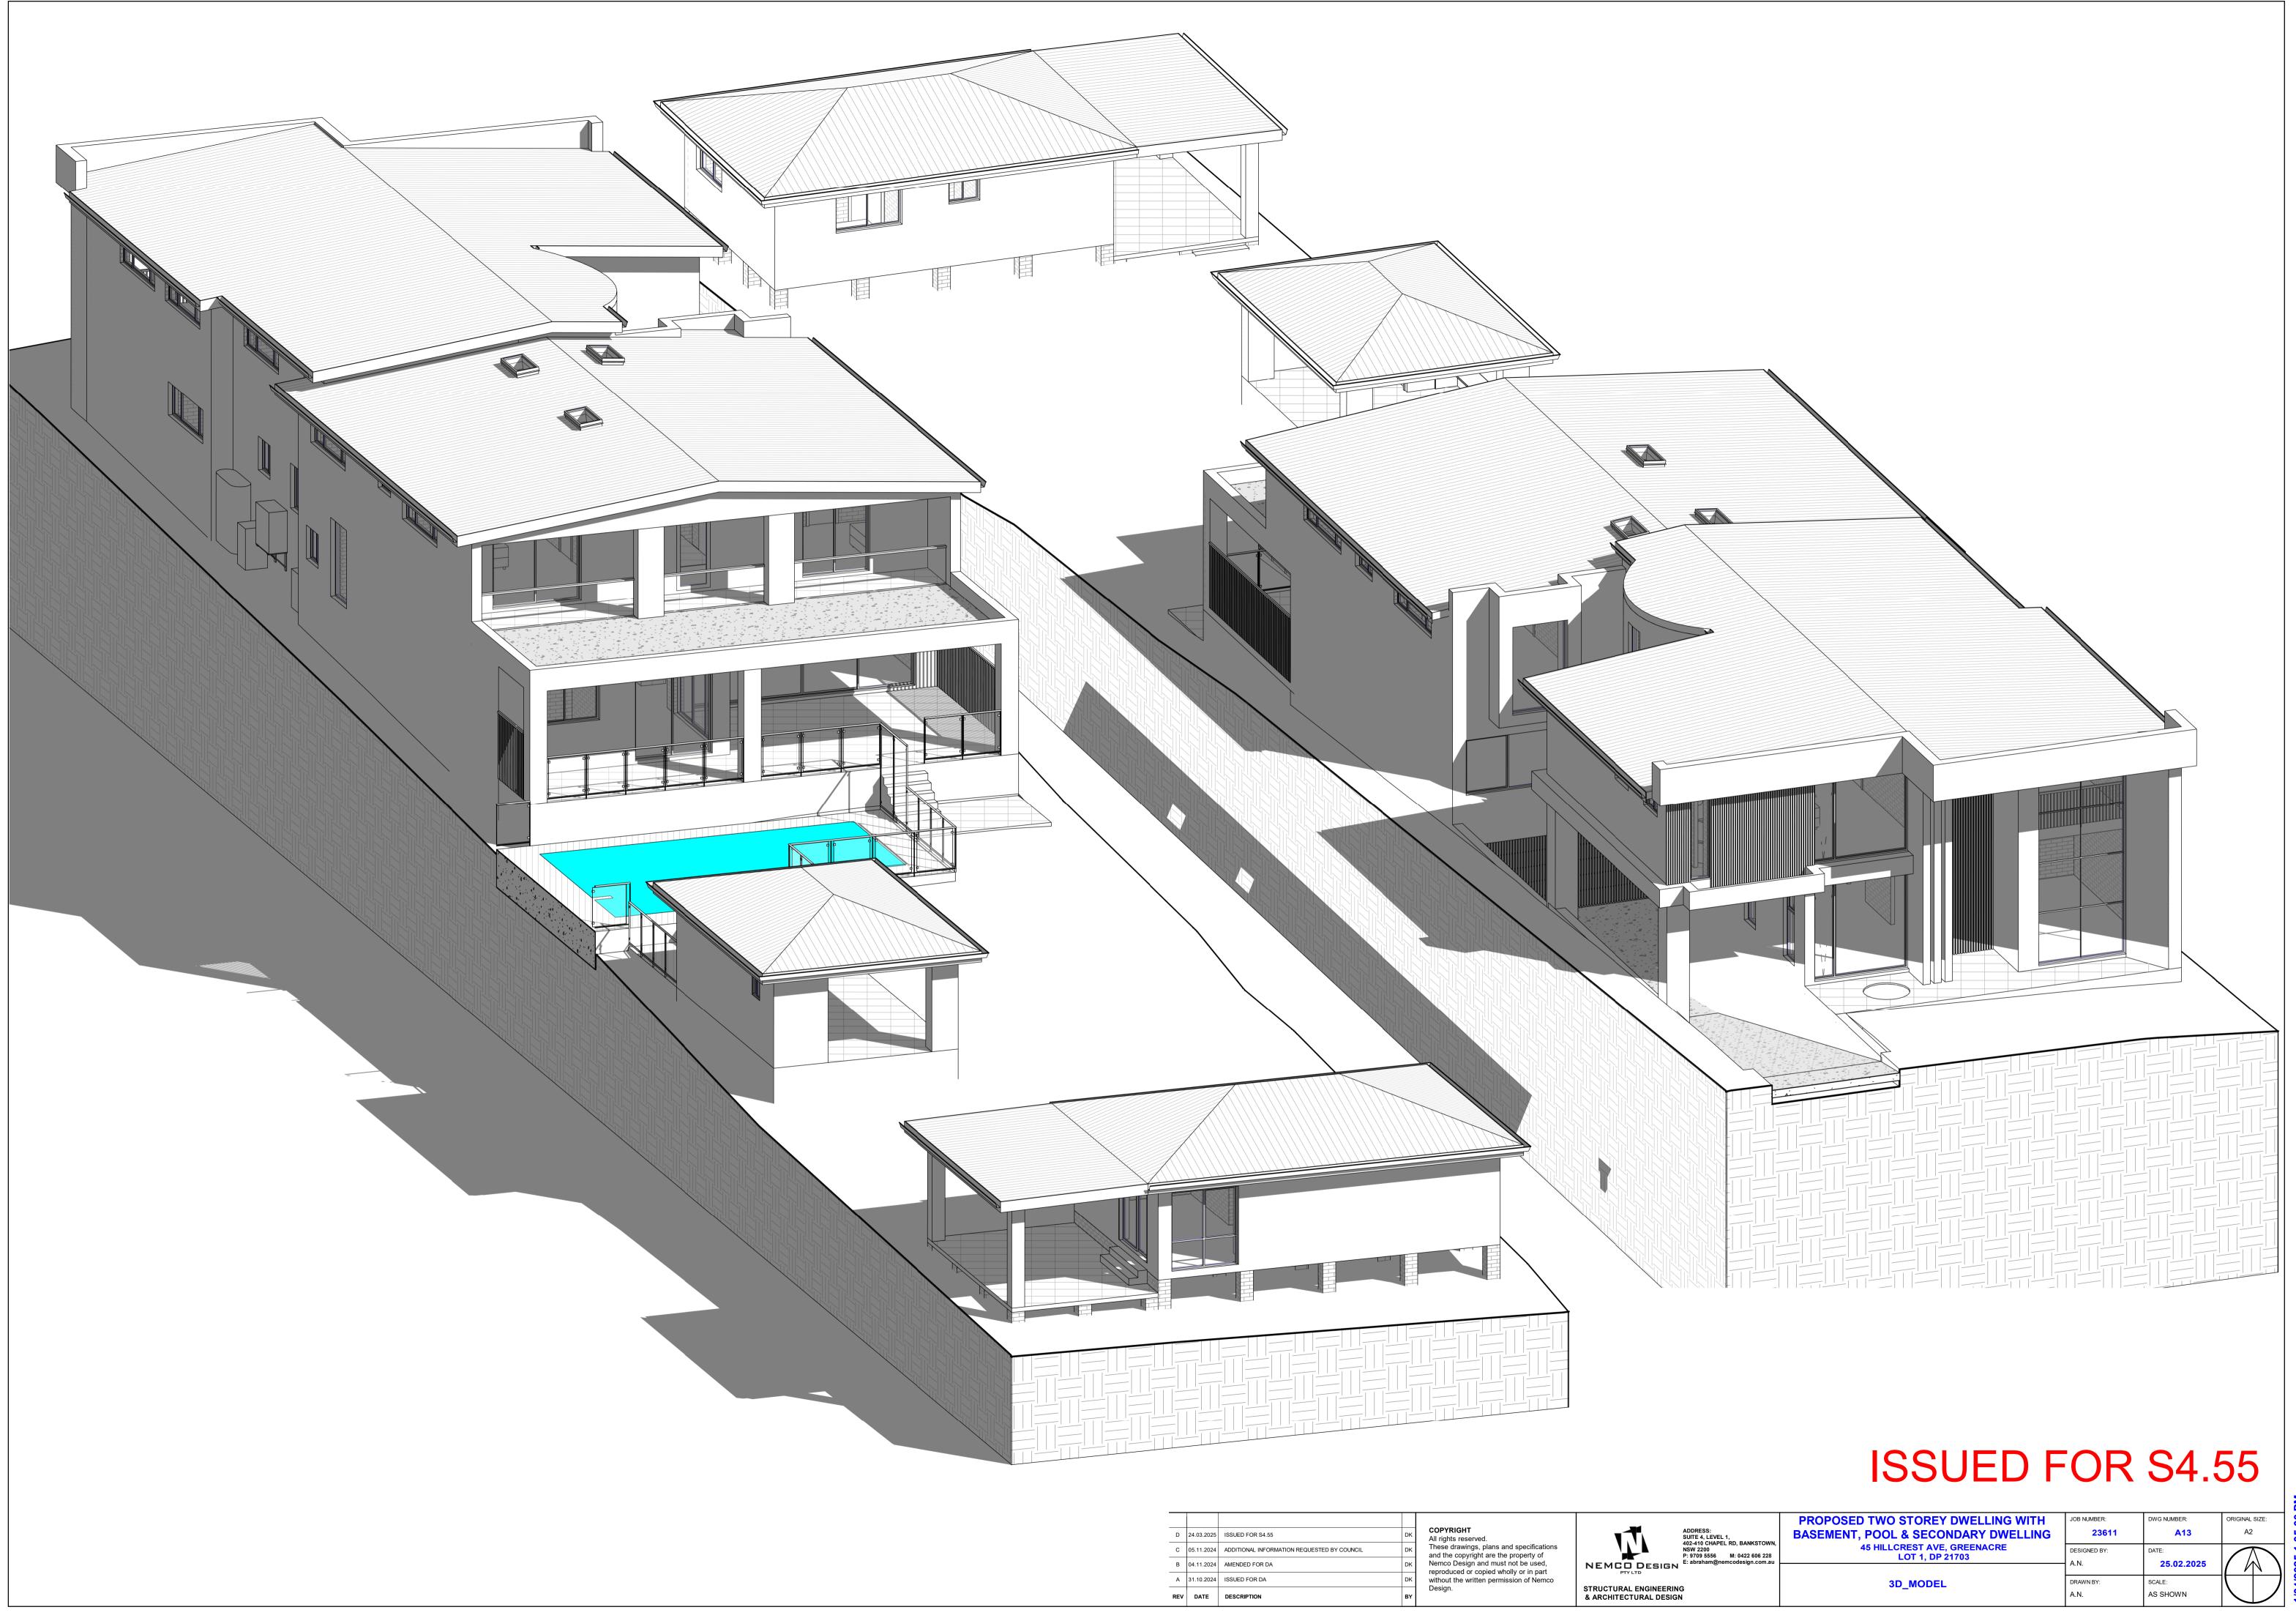
	PROPOSED TWO STOREY DWELLING WITH BASEMENT, POOL & SECONDARY DWELLING	JOB NUMBER: 23611	DWG NUMBER:	ORIGINAL SIZE: A2	
TOWN, 6 228 om.au	45 HILLCREST AVE, GREENACRE LOT 1, DP 21703	DESIGNED BY: A.N.	DATE: 25.02.2025		
	DRIVEWAY SECTION	DRAWN BY: A.N.	SCALE: AS SHOWN		



ISSUED F			
TWO STOREY DWELLING WITH	JOB NUMBER:	DWG NUMBER:	ORIGINAL SIZE:
POOL & SECONDARY DWELLING	23611	A10	A2
5 HILLCREST AVE, GREENACRE	DESIGNED BY:	DATE:	







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& ARCHITECTURAL

NKSTOWN.	PROPOSED TWO STOREY DWELLING WITH BASEMENT, POOL & SECONDARY DWELLING	JOB NUMBER: 23611	DWG NUMBER:	ORIGINAL SIZE: A2
2 606 228 In.com.au	45 HILLCREST AVE, GREENACRE LOT 1, DP 21703	DESIGNED BY: A.N.	DATE: 25.02.2025	
	3D_MODEL	DRAWN BY: A.N.	SCALE: AS SHOWN	



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	PROPOSED TWO STOREY DWELLING WITH	JOB NUMBER:	DWG NUMBER:	ORIGINAL SIZE:
TOWN.	BASEMENT, POOL & SECONDARY DWELLING	23611	A14	A2
6 228 om.au	45 HILLCREST AVE, GREENACRE LOT 1, DP 21703	DESIGNED BY: A.N.	DATE: 25.02.2025	
			25.02.2025	
	3D_MODEL	DRAWN BY:	SCALE:	
		A.N.	AS SHOWN	

V	VINDOV	VS SCHE	EDULE - DV	VELLING
Mark	Height	Width	Area	Level
				-
W1.1	5500	2400	13.20 m²	GF
W1.2	2700	2590	6.99 m²	GF
W1.3	2500	800	2.00 m ²	GF
W1.4	2500	800	2.00 m ²	GF
W1.5	2500	800	2.00 m ²	GF
W1.6	5500	800	4.40 m ²	GF
W1.7	5500	800	4.40 m ²	GF
W1.8	5500	800	4.40 m ²	GF
W1.9	1200	1810	2.17 m²	LGF1
W1.10	1200	1450	1.74 m²	GF
W1.11	900	900	0.81 m²	GF
W1.12	900	2650	2.39 m ²	GF
W1.13	2300	2590	5.96 m ²	FF
W1.14	2300	590	1.36 m²	FF
W1.15	600	970	0.58 m²	FF
W1.16	600	970	0.58 m²	FF
W1.17	2400	1500	3.60 m²	LFF
W1.18	900	2650	2.39 m ²	LFF
W1.19	850	1210	1.03 m²	LFF
W1.20	900	2650	2.39 m²	LFF
W1.21	900	2650	2.39 m²	LFF
W1.22	600	970	0.58 m²	LFF
W1.23	900	2650	2.39 m ²	LFF
W1.24	600	970	0.58 m²	FF
W1.25	900	2650	2.39 m²	FF
W1.26	900	2650	2.39 m²	FF
W1.27	900	2650	2.39 m²	FF
W1.28	1500	3510	5.27 m²	LGF1
W1.29	900	900	0.81 m²	LGF1
W1.30	2100	1210	2.54 m²	GF
W1.31	600	600	0.36 m²	CAB FFL
Grand total: 31 86.44 m ²				

GLASS DOORS SCHEDULE - DWELLING					
Mark	Height	Width	Area	Level	
GD1.1	2400	920	2.21 m ²	LFF	
SD1.3	2400	6000	14.40 m²	LGF1	
SD1.4	2400	3200	7.68 m²	LGF1	
SD1.5	2400	2100	5.04 m²	LGF1	
SD1.6	2400	1810	4.34 m²	LFF	
SD1.7	2400	2400	5.76 m²	LFF	
Grand total: 6 39.43 m ²					

SKYLIGHT SCHEDULE - DWELLING						
Mark	Height	Width	Area	Level		
SK1.1	580	1180	0.68 m²	LCL2		
SK1.2	580	1180	0.68 m²	LCL2		
SK1.3	580	1180	0.68 m²	LCL2		
Grand total: 3 2.05 m ²						

WINDOWS SCHEDULE - GRANNY FLAT						
Mark	Height	Width	Area	Level		
W2.1	600	850	0.51 m²	GF - GRANNY		
W2.2	970	1810	1.76 m²	GF - GRANNY		
W2.3	970	1810	1.76 m²	GF - GRANNY		
W2.4	2100	1810	3.80 m²	GF - GRANNY		
Grand total: 4			7.82 m ²			

GLASS DOORS SCHEDULE - GRANNY FLAT					
Mark	Height	Width	Area	Level	
SD2.1	2100	2100	4.41 m ²	GF - GRANNY	
Grand total: 1 4.41			4.41 m²		

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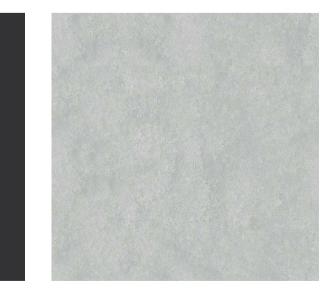
OWN.	PROPOSED TWO STOREY DWELLING WITH	JOB NUMBER:	DWG NUMBER:	ORIGINAL SIZE:
	BASEMENT, POOL & SECONDARY DWELLING	23611	A15	A2
228	45 HILLCREST AVE, GREENACRE	DESIGNED BY:	DATE:	
om.au	LOT 1, DP 21703	A.N.		
	WINDOWS & DOORS SCHEDULE	DRAWN BY:	SCALE: AS SHOWN	





01: MONUMENT





02: CEMENT FINISH



03: STONE FEATURE



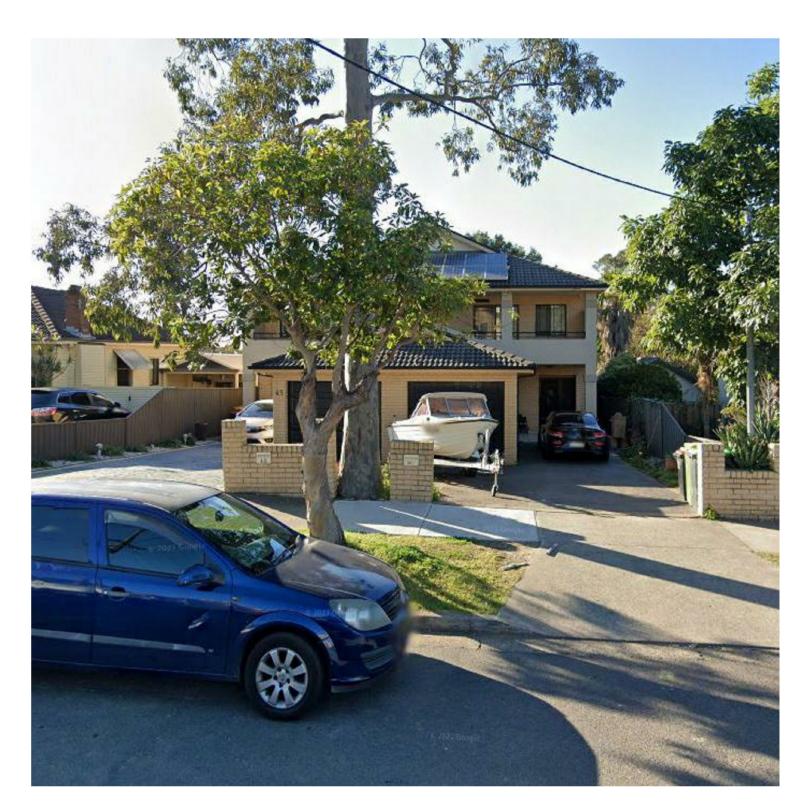
04: ALUMINIUM WINDOWS & DOORS

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TOWN.	PROPOSED TWO STOREY DWELLING WITH BASEMENT, POOL & SECONDARY DWELLING	JOB NUMBER: 23611	DWG NUMBER: A16	ORIGINAL SIZE: A2
6 228 om.au	45 HILLCREST AVE, GREENACRE LOT 1, DP 21703	DESIGNED BY: A.N.	DATE: 25.02.2025	
		A.N.	25.02.2025	
	SCHEDULE OF MATERIALS & FINISHES	DRAWN BY:	SCALE:	
		A.N.	AS SHOWN	$ \setminus / $

No. 43

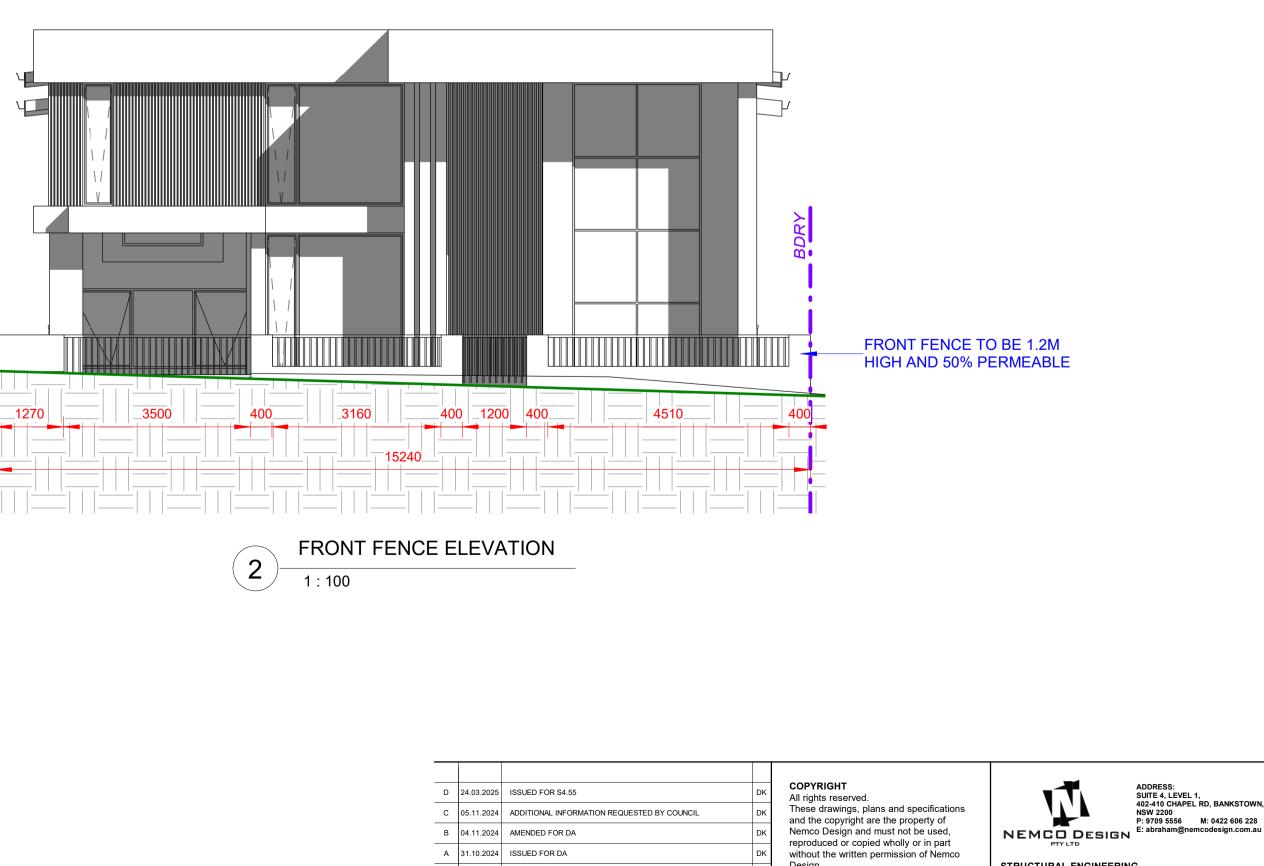








HILLCREST AVENUE



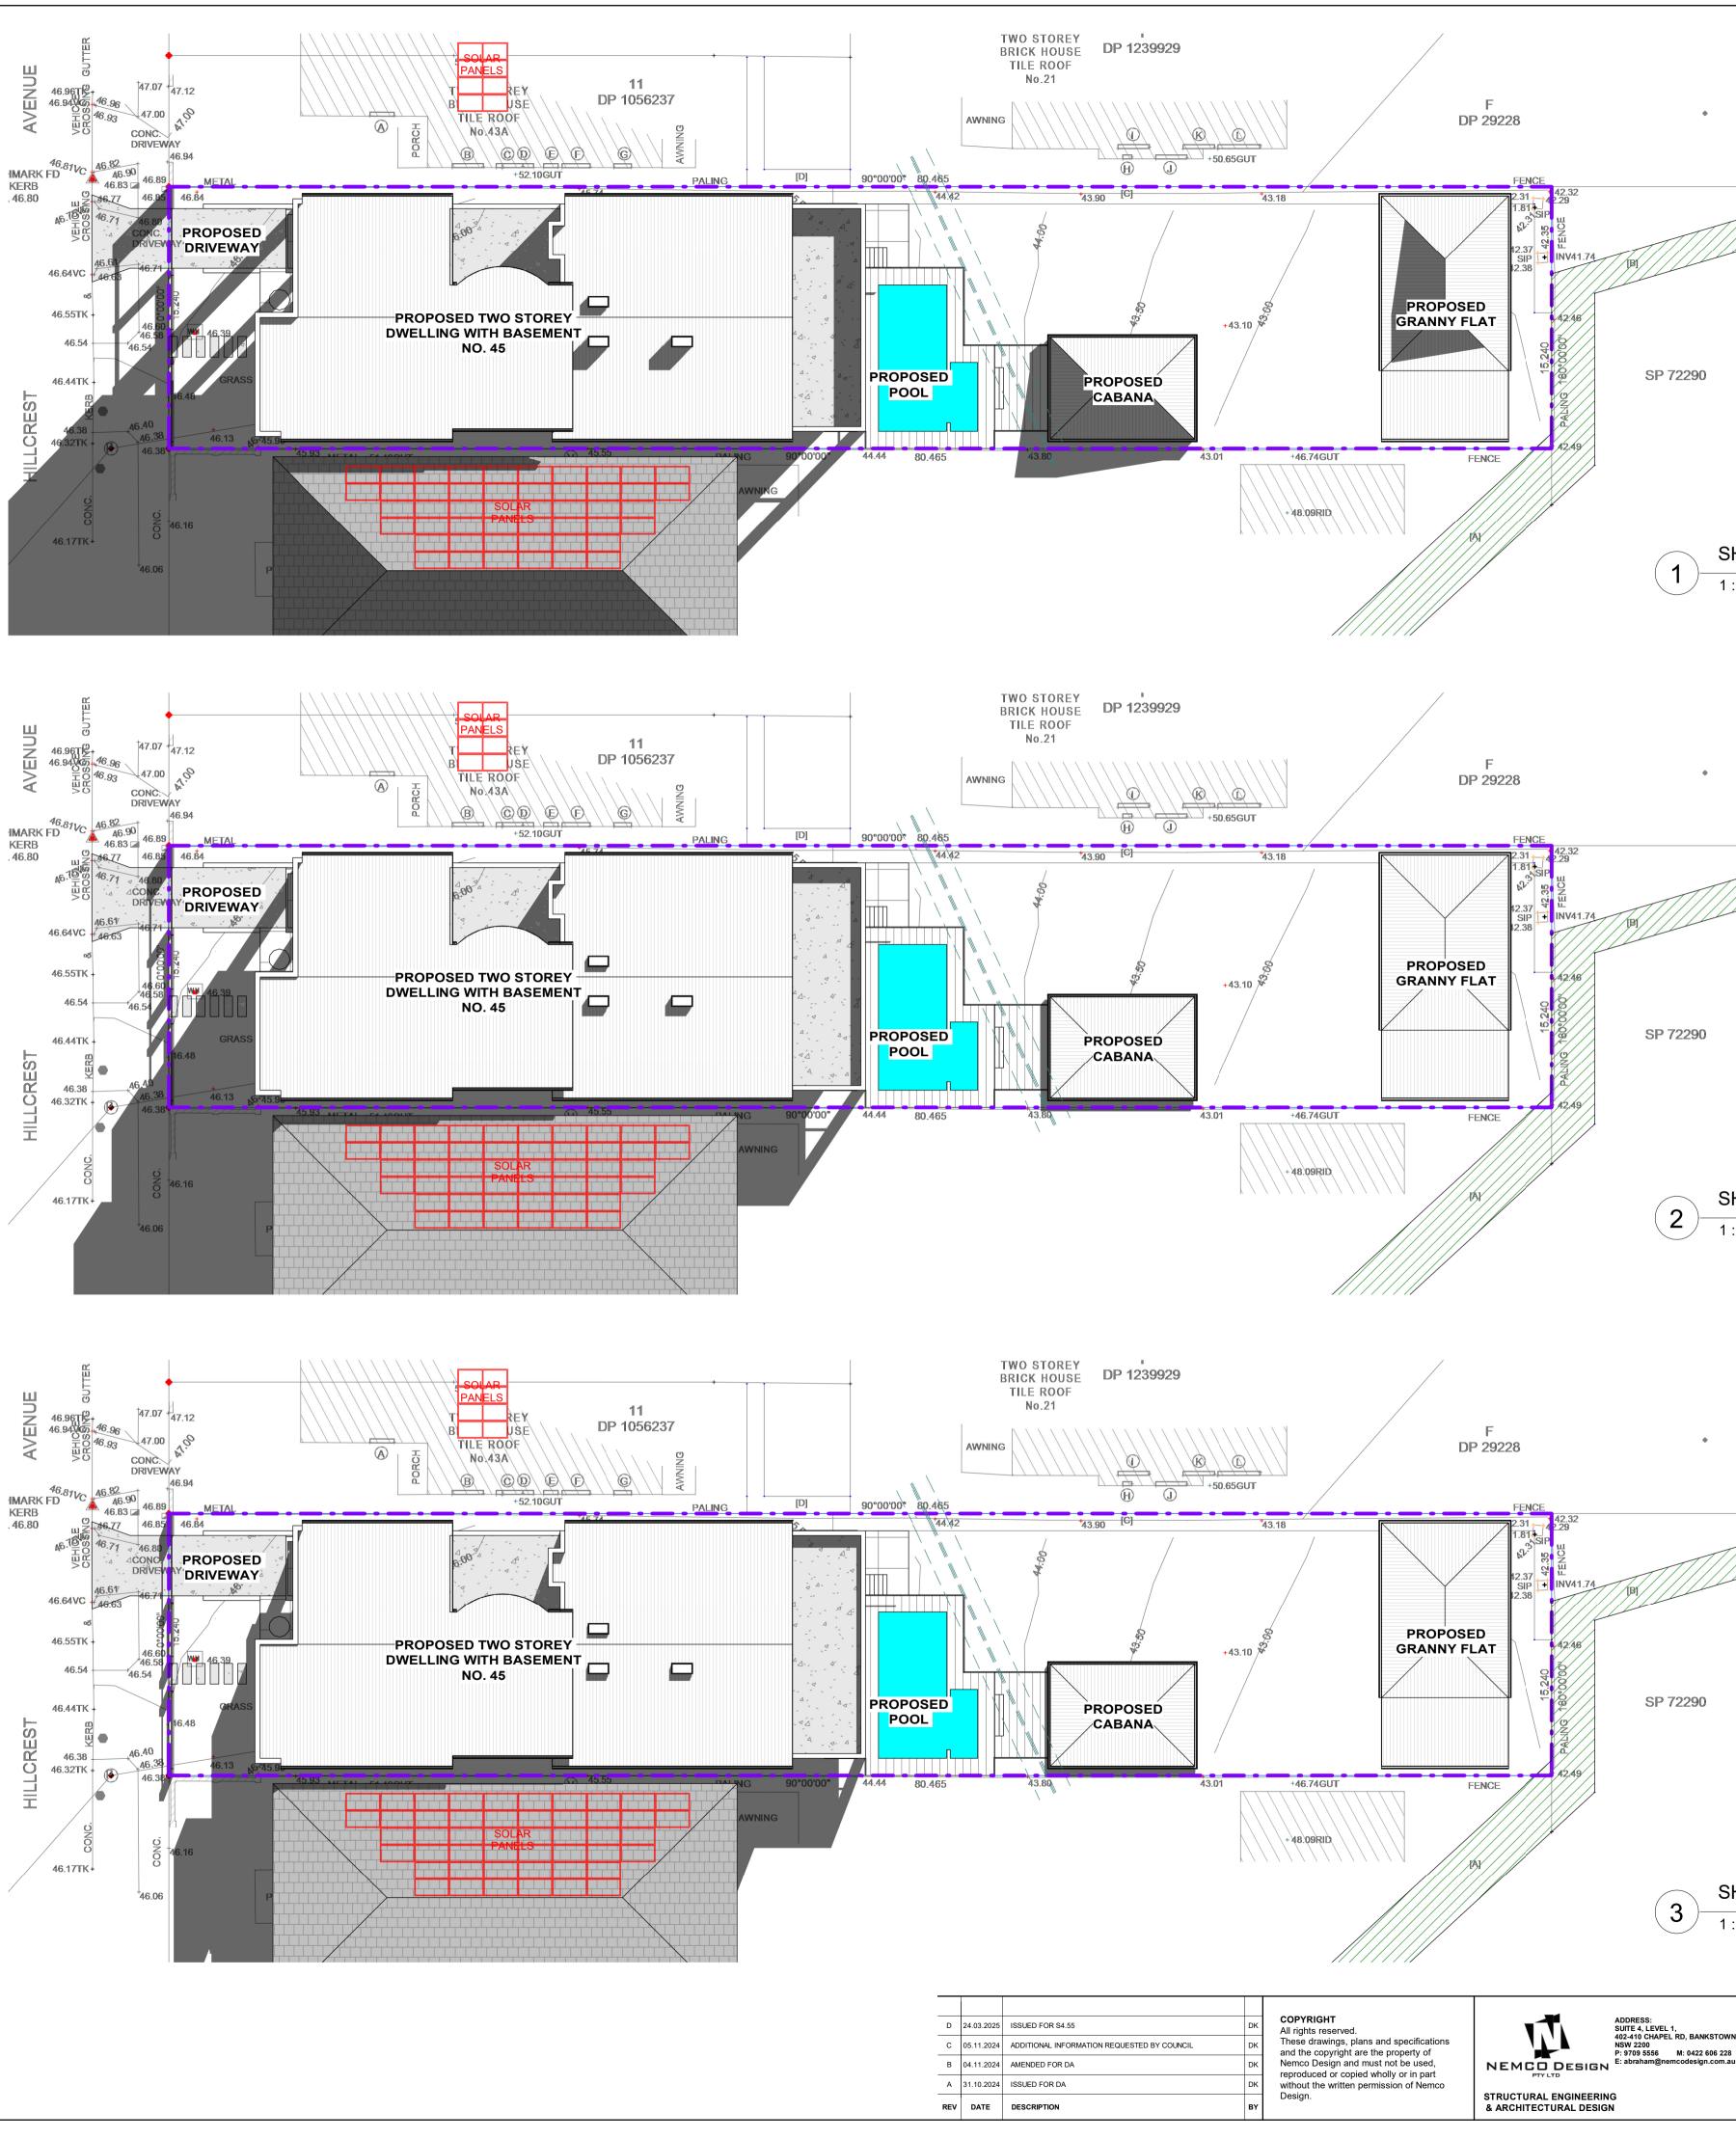
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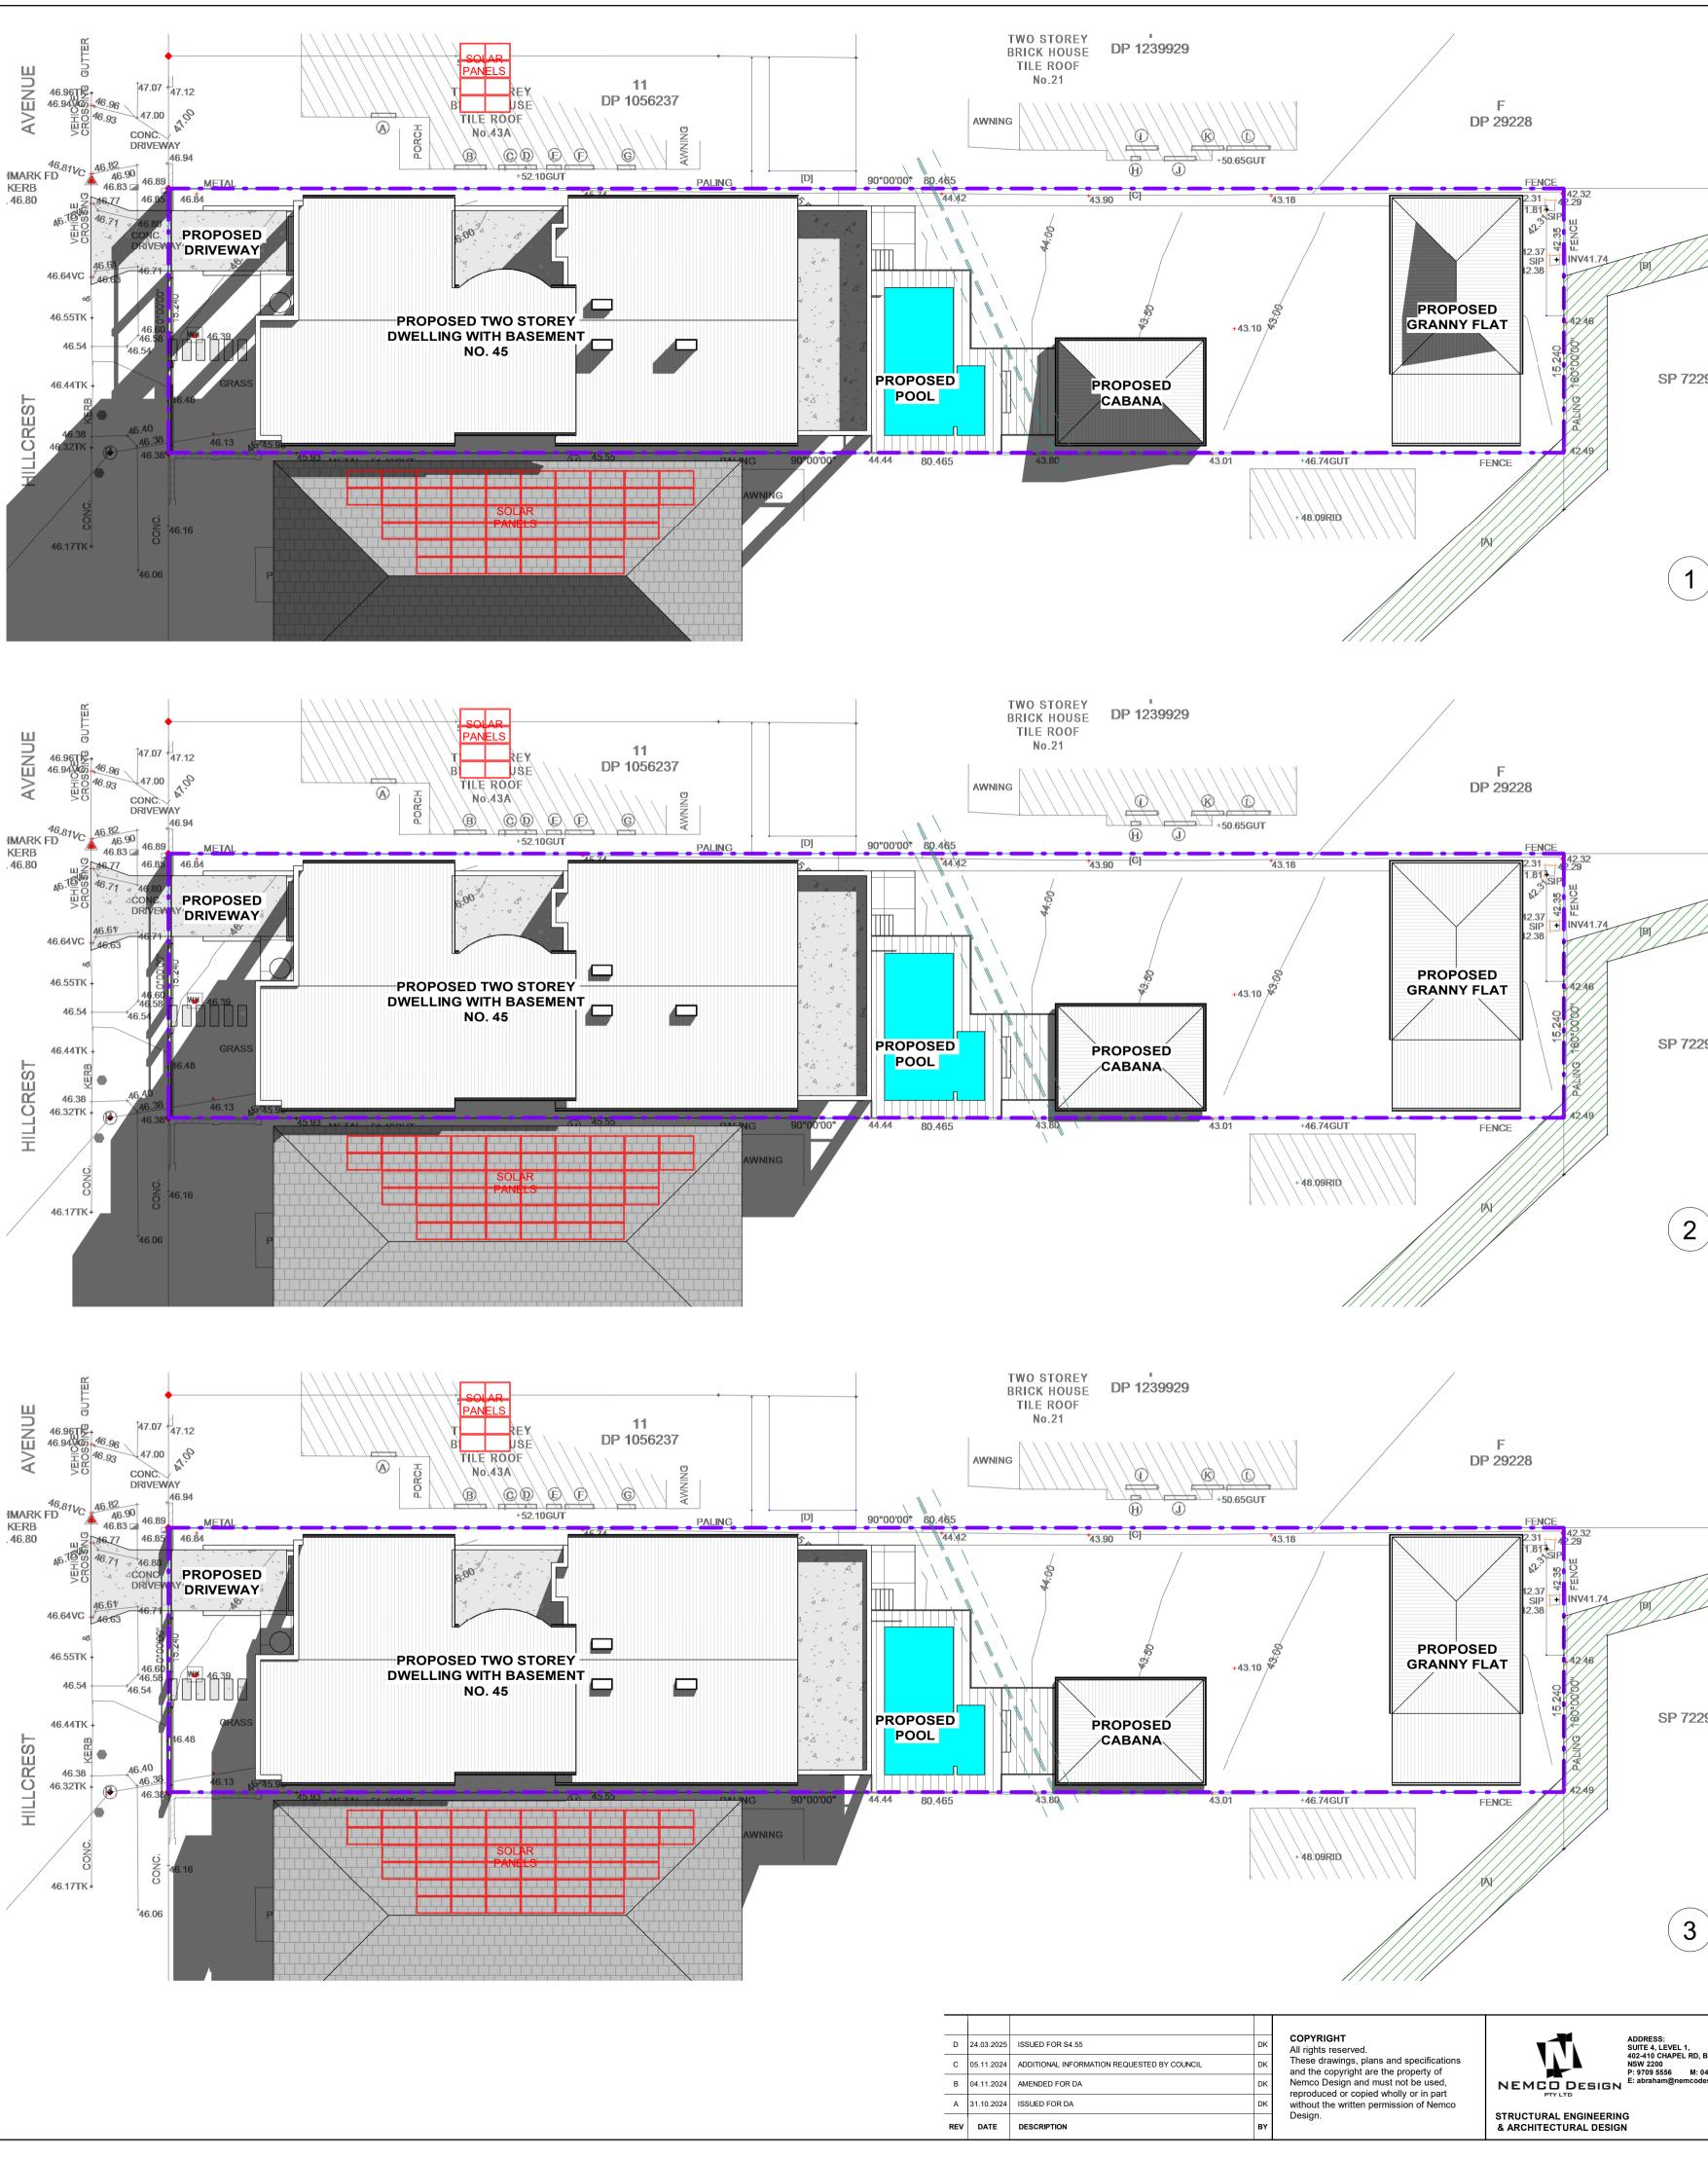
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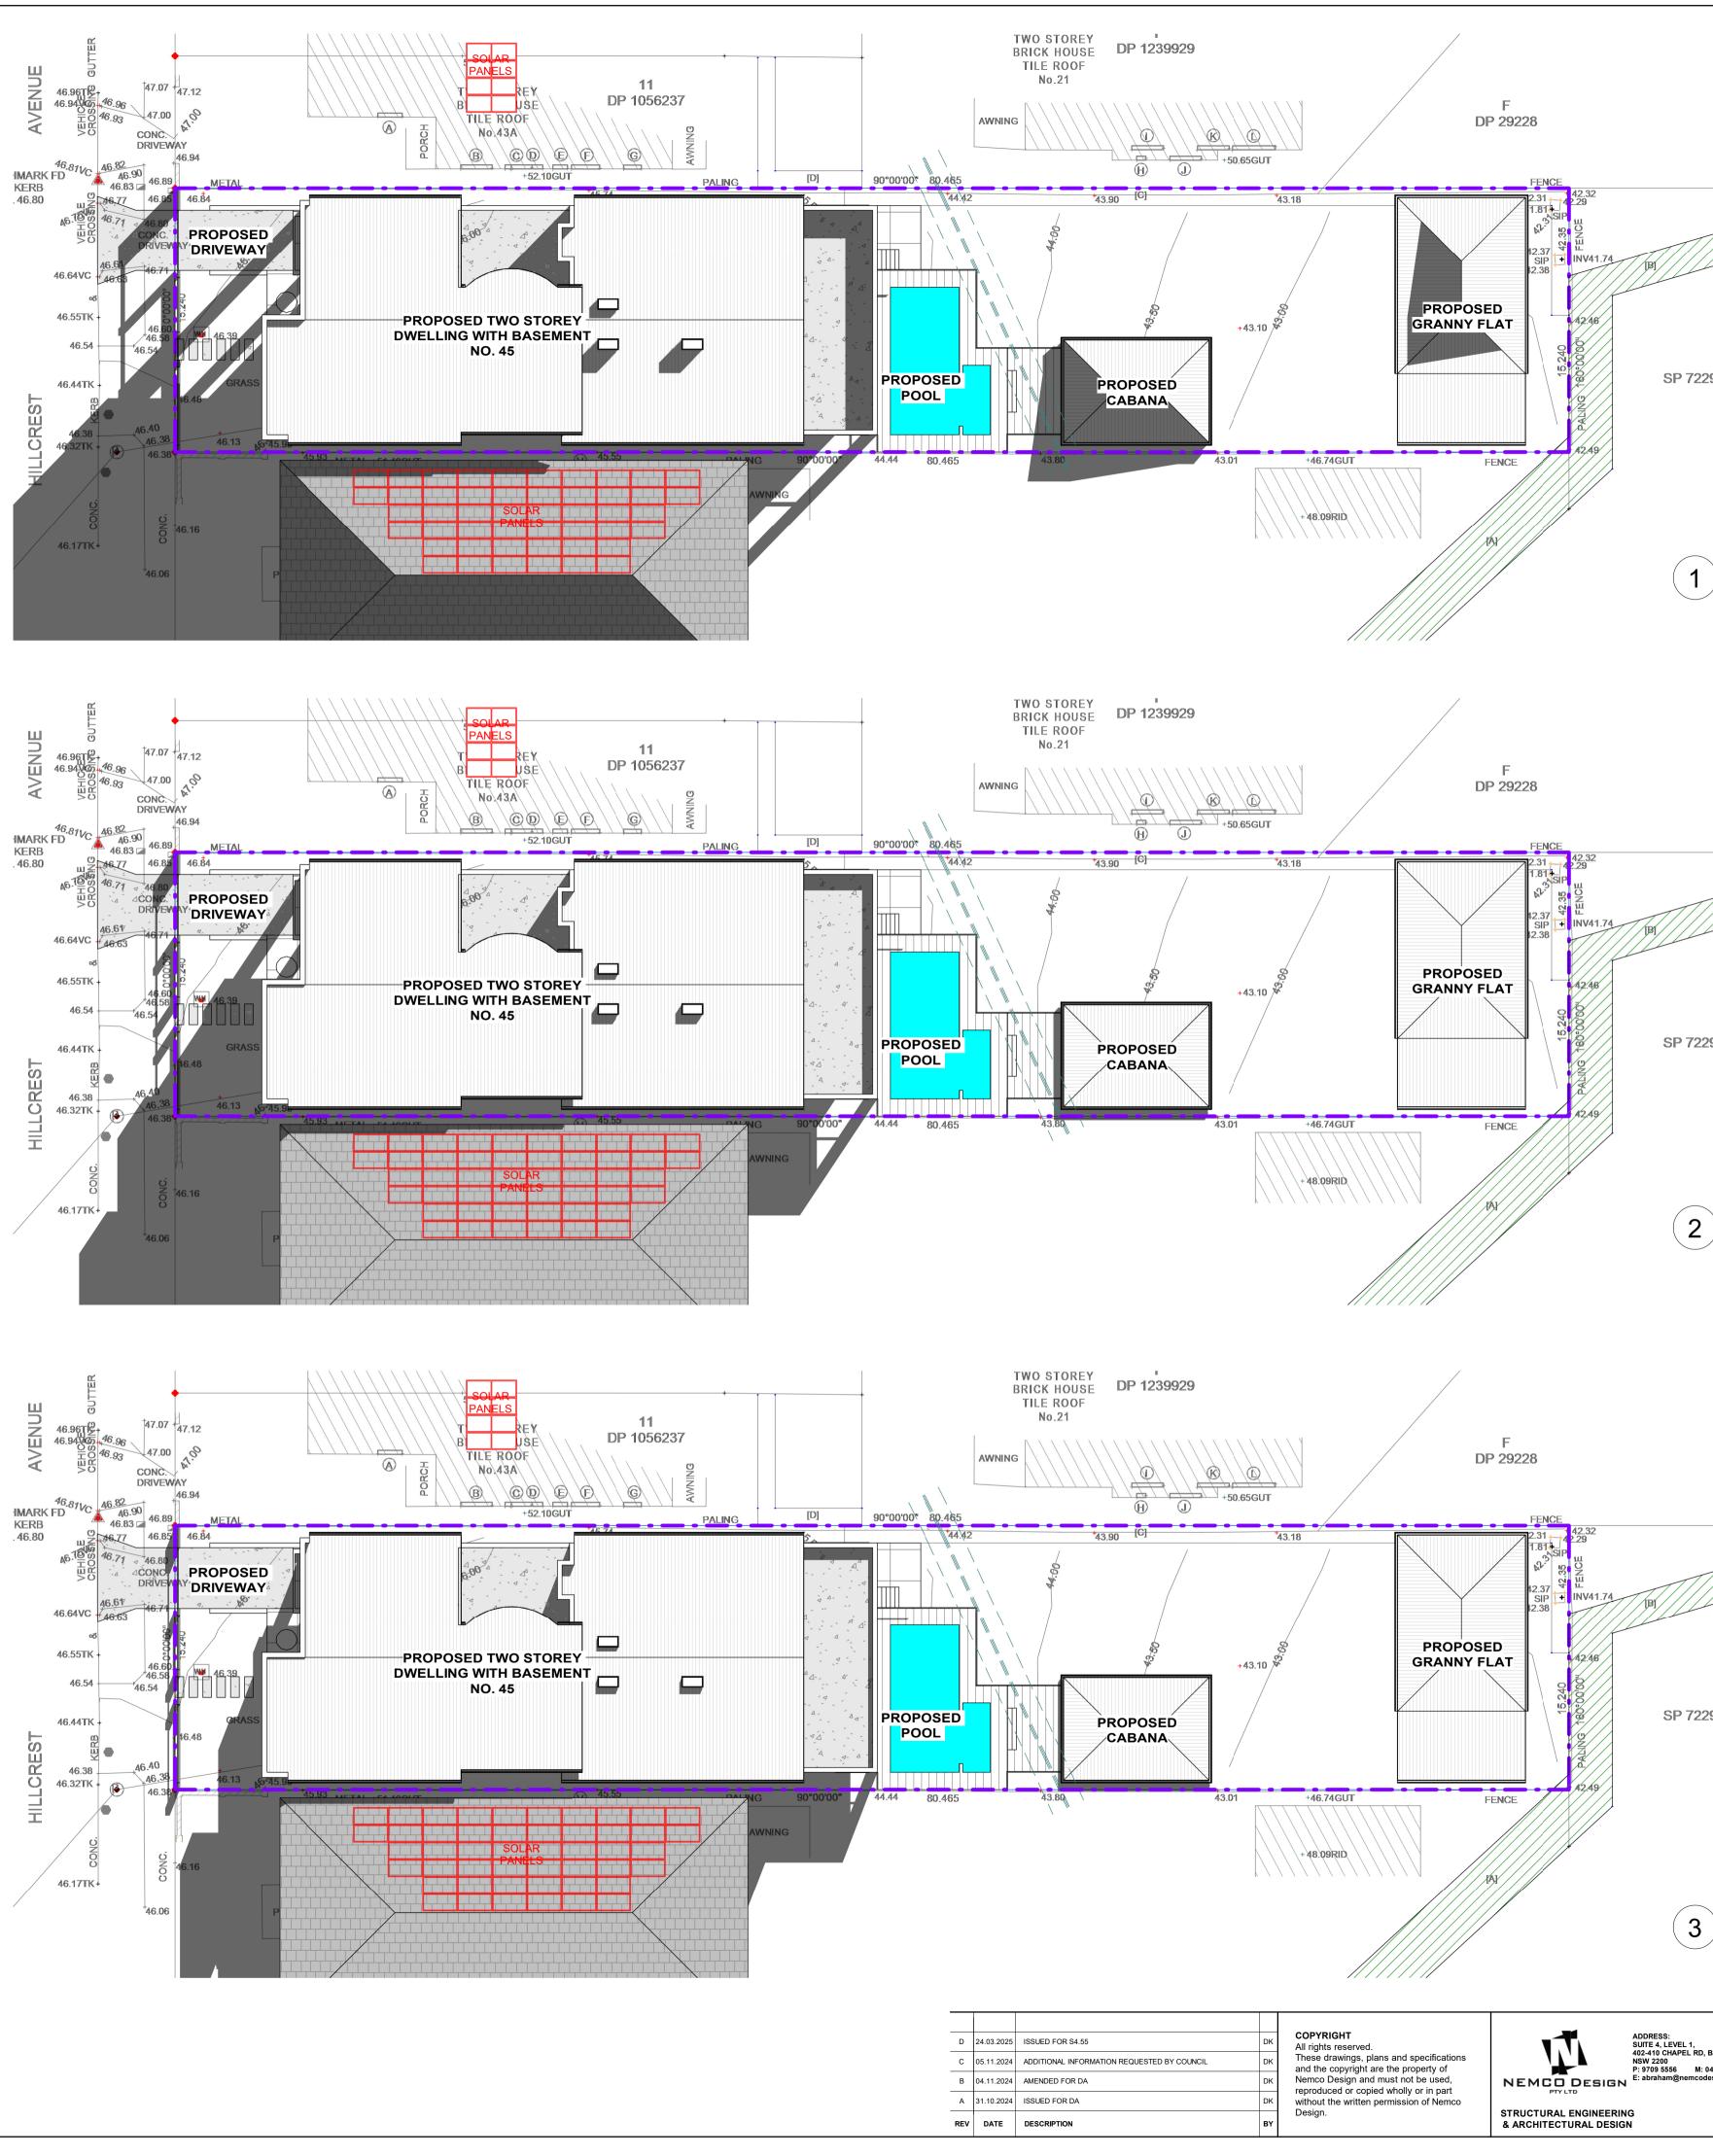
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	PROPOSED TWO STOREY DWELLING WITH	JOB NUMBER:	DWG NUMBER:	ORIGINAL SIZE:
STOWN.	BASEMENT, POOL & SECONDARY DWELLING	23611	A17	A2
06 228 com.au	45 HILLCREST AVE, GREENACRE LOT 1, DP 21703	DESIGNED BY:	DATE: 25.02.2025	
		A.D.	20.02.2025	
	STREETSCAPE VIEW & FRONT FENCE	DRAWN BY:	SCALE:	
	ELEVATION	A.N.	AS SHOWN	







SHADOW DIAGRAM - 21ST JUN 10AM **ISSUED FOR S4.55** 1 : 300

	PROPOSED TWO STOREY DWELLING WITH	JOB NUMBER:	DWG NUMBER:	ORIGINAL SIZE:
	BASEMENT, POOL & SECONDARY DWELLING	23611	A18.01	A2
3ANKSTOWN, 422 606 228 esign.com.au	45 HILLCREST AVE, GREENACRE LOT 1, DP 21703	DESIGNED BY:	DATE: 25.02.2025	
	SHADOW DIAGRAM - 21ST JUN			
		DRAWN BY: A.N.	SCALE: AS SHOWN	\bigvee

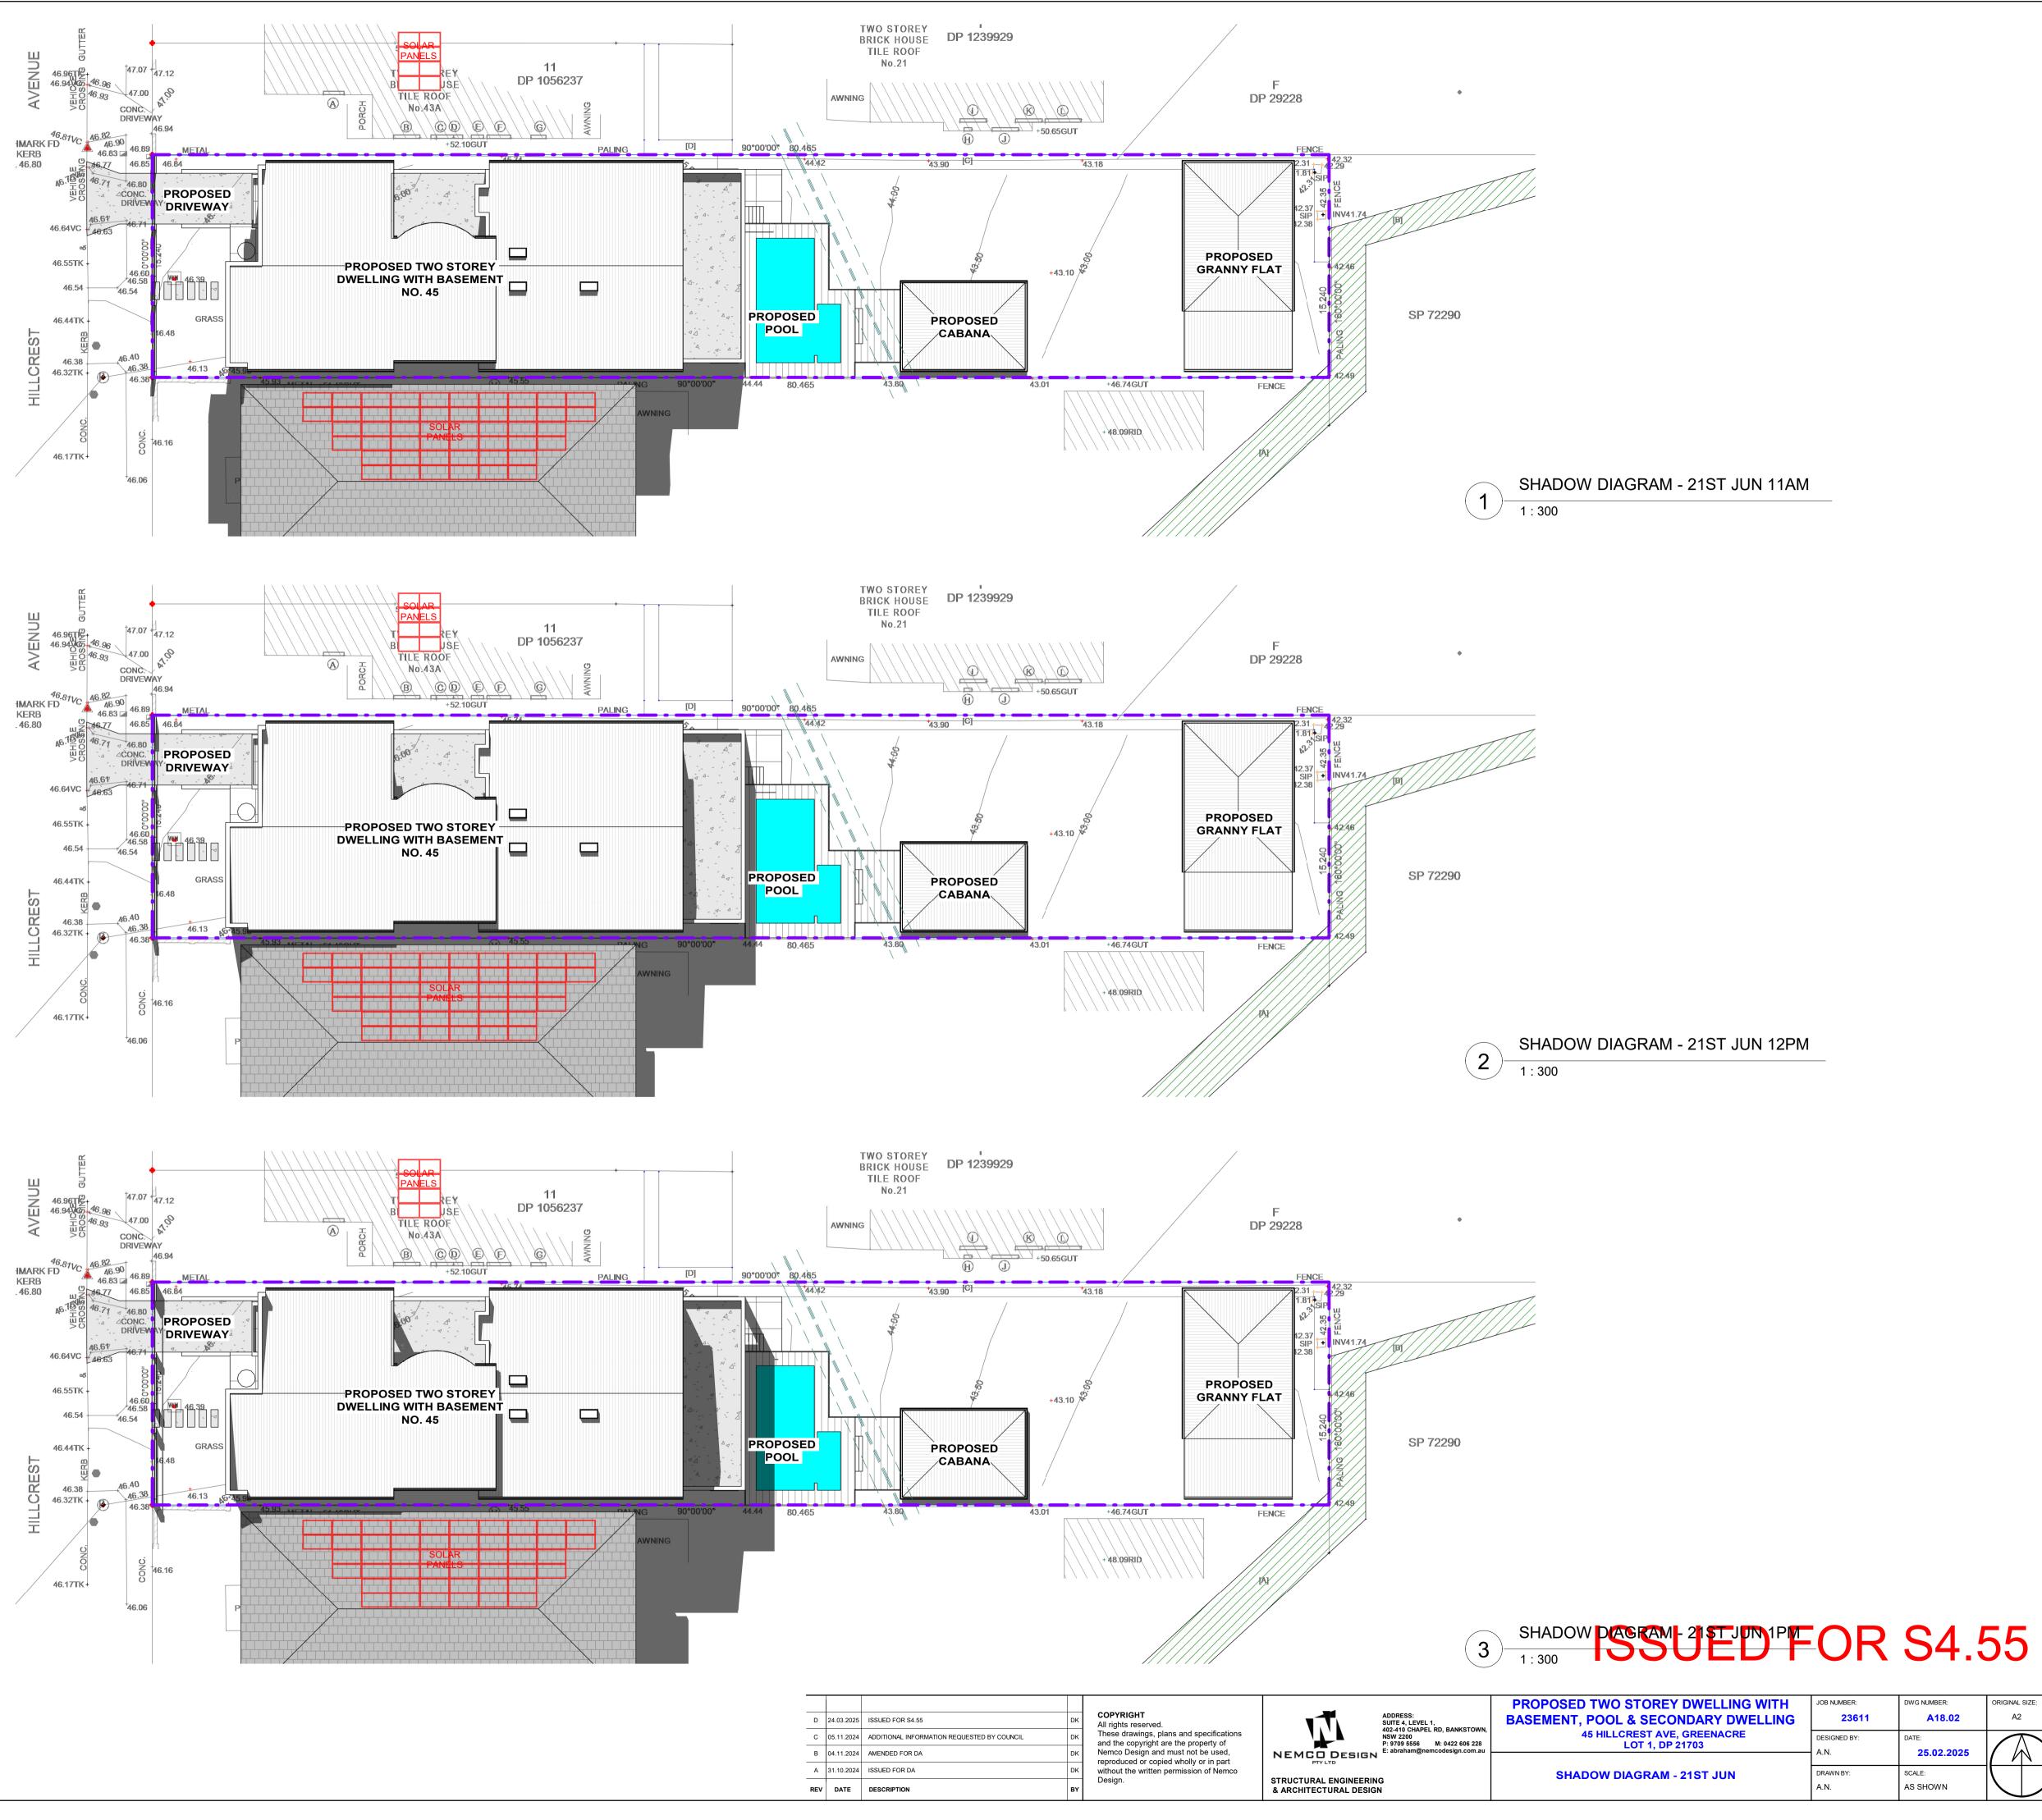
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SHADOW DIAGRAM - 21ST JUN 9AM

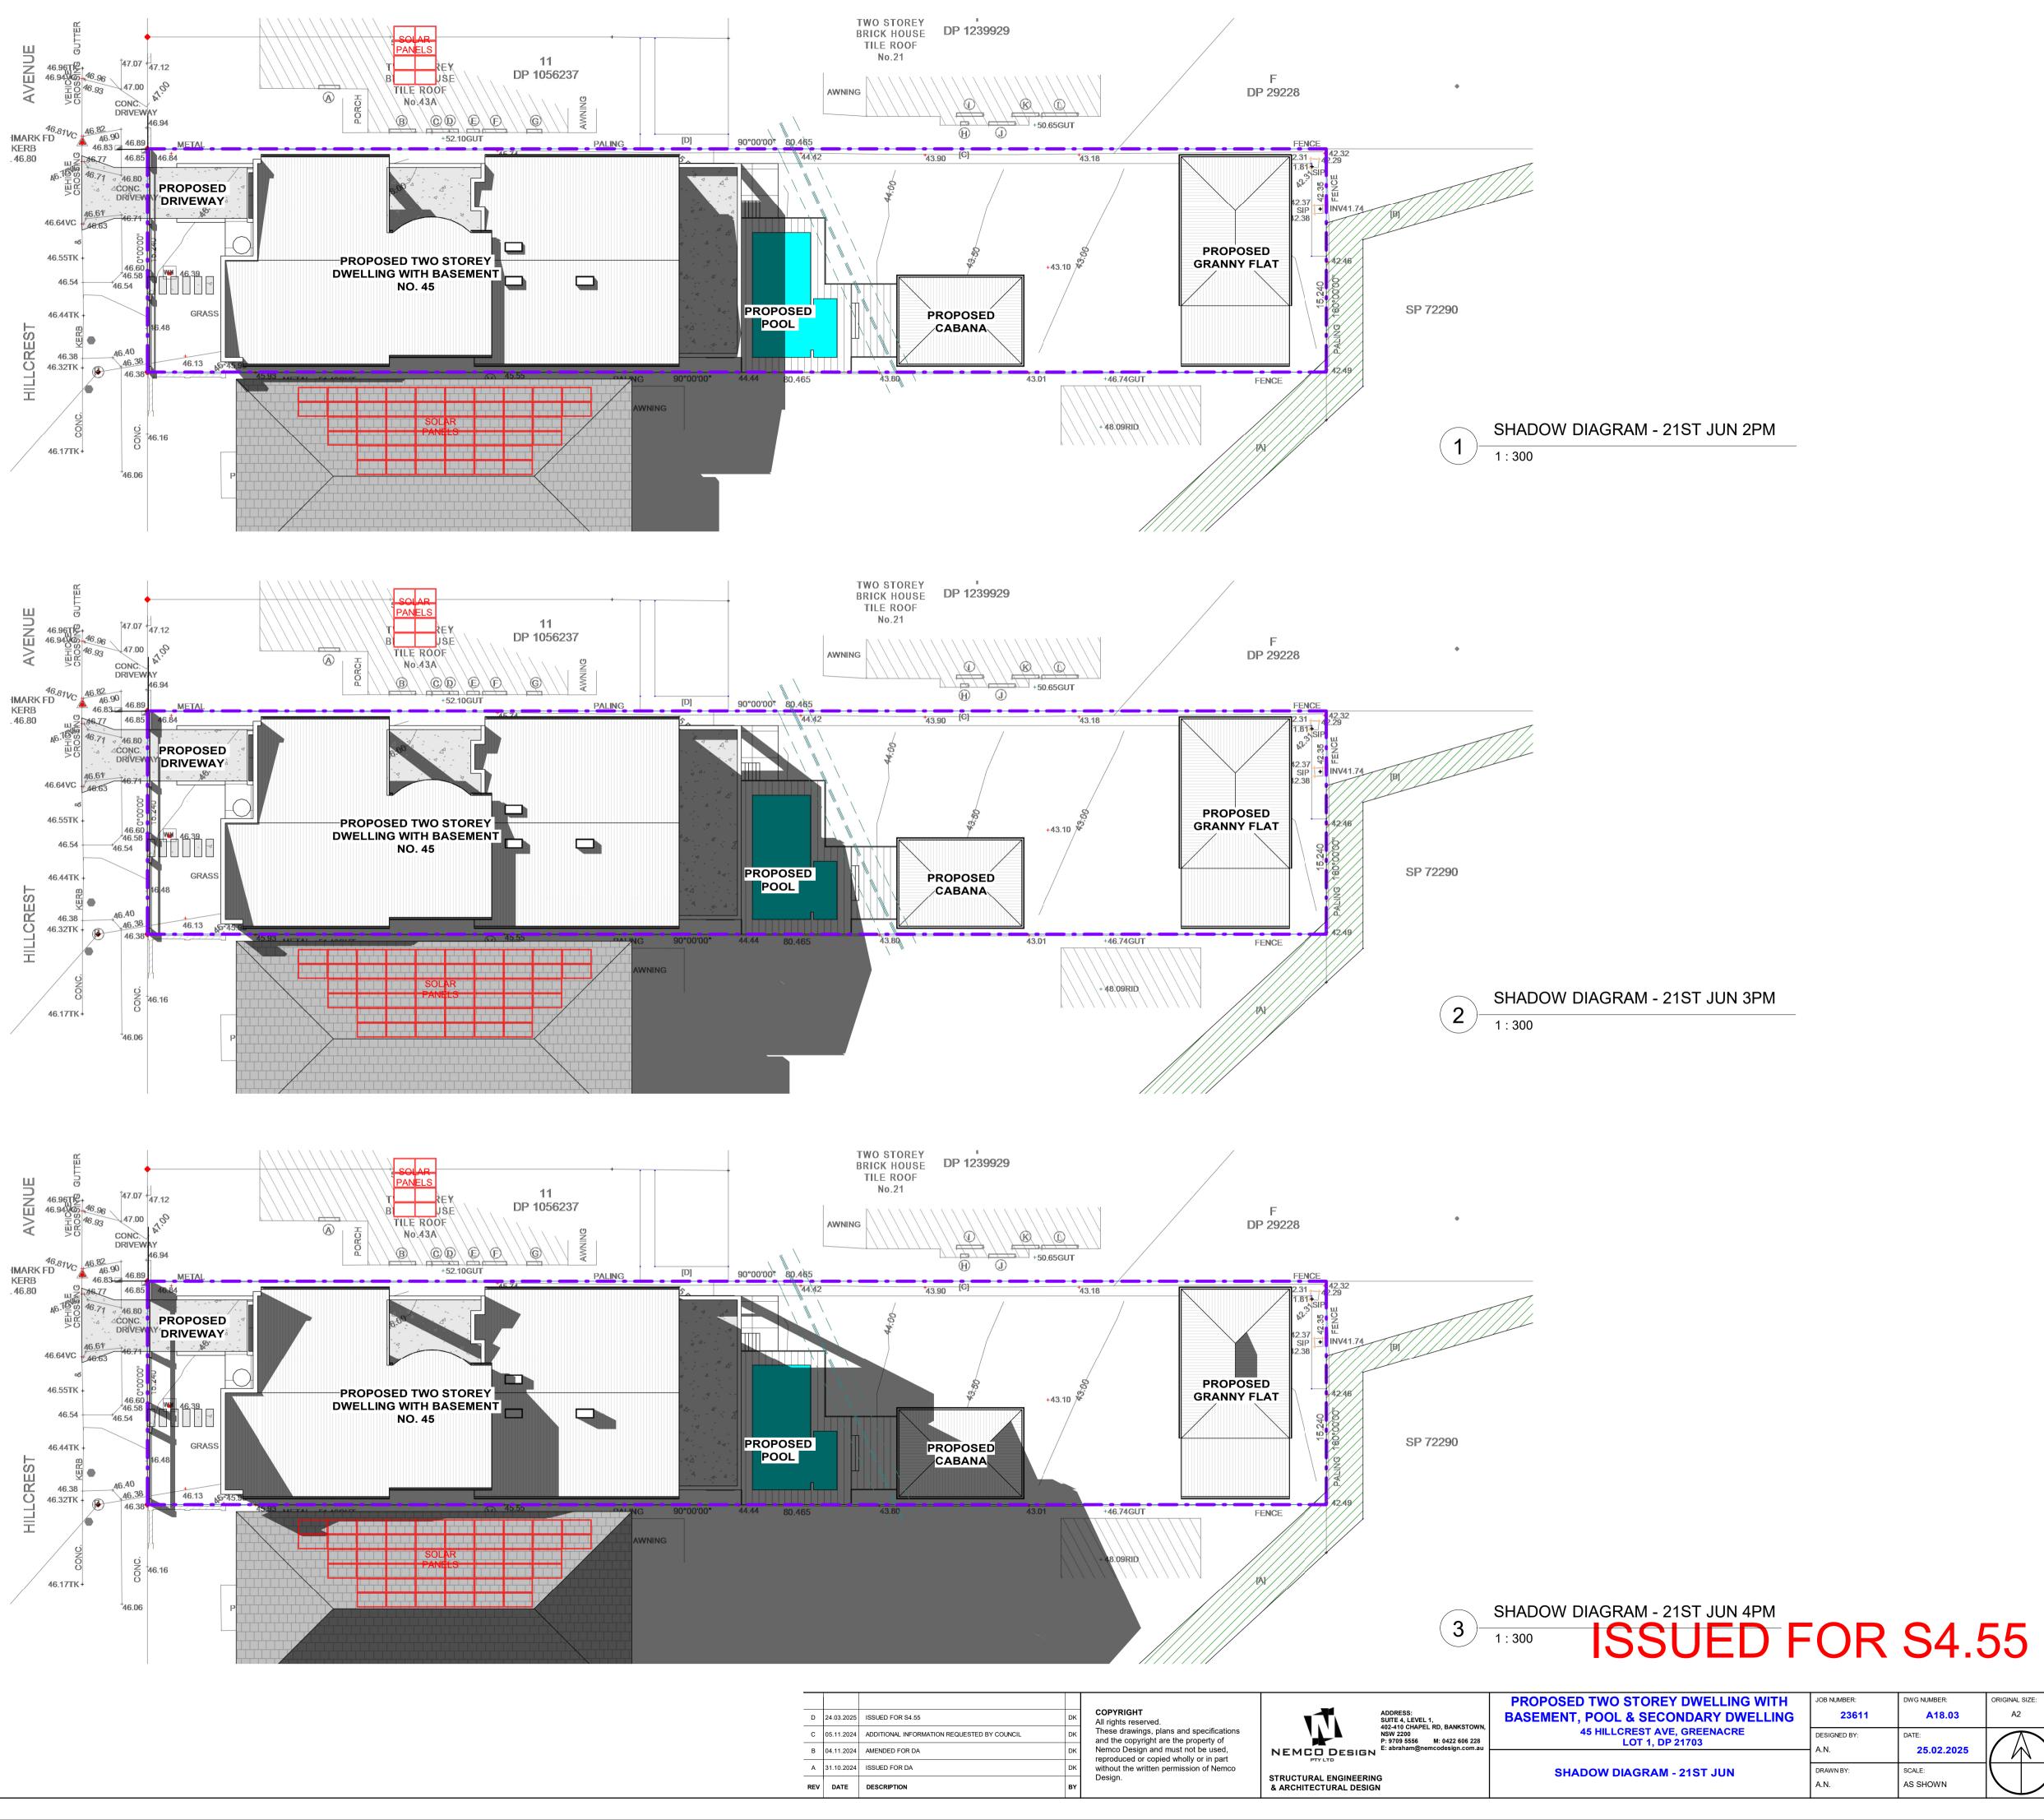
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SHADOW DIAGRAM - 21ST JUN 8AM

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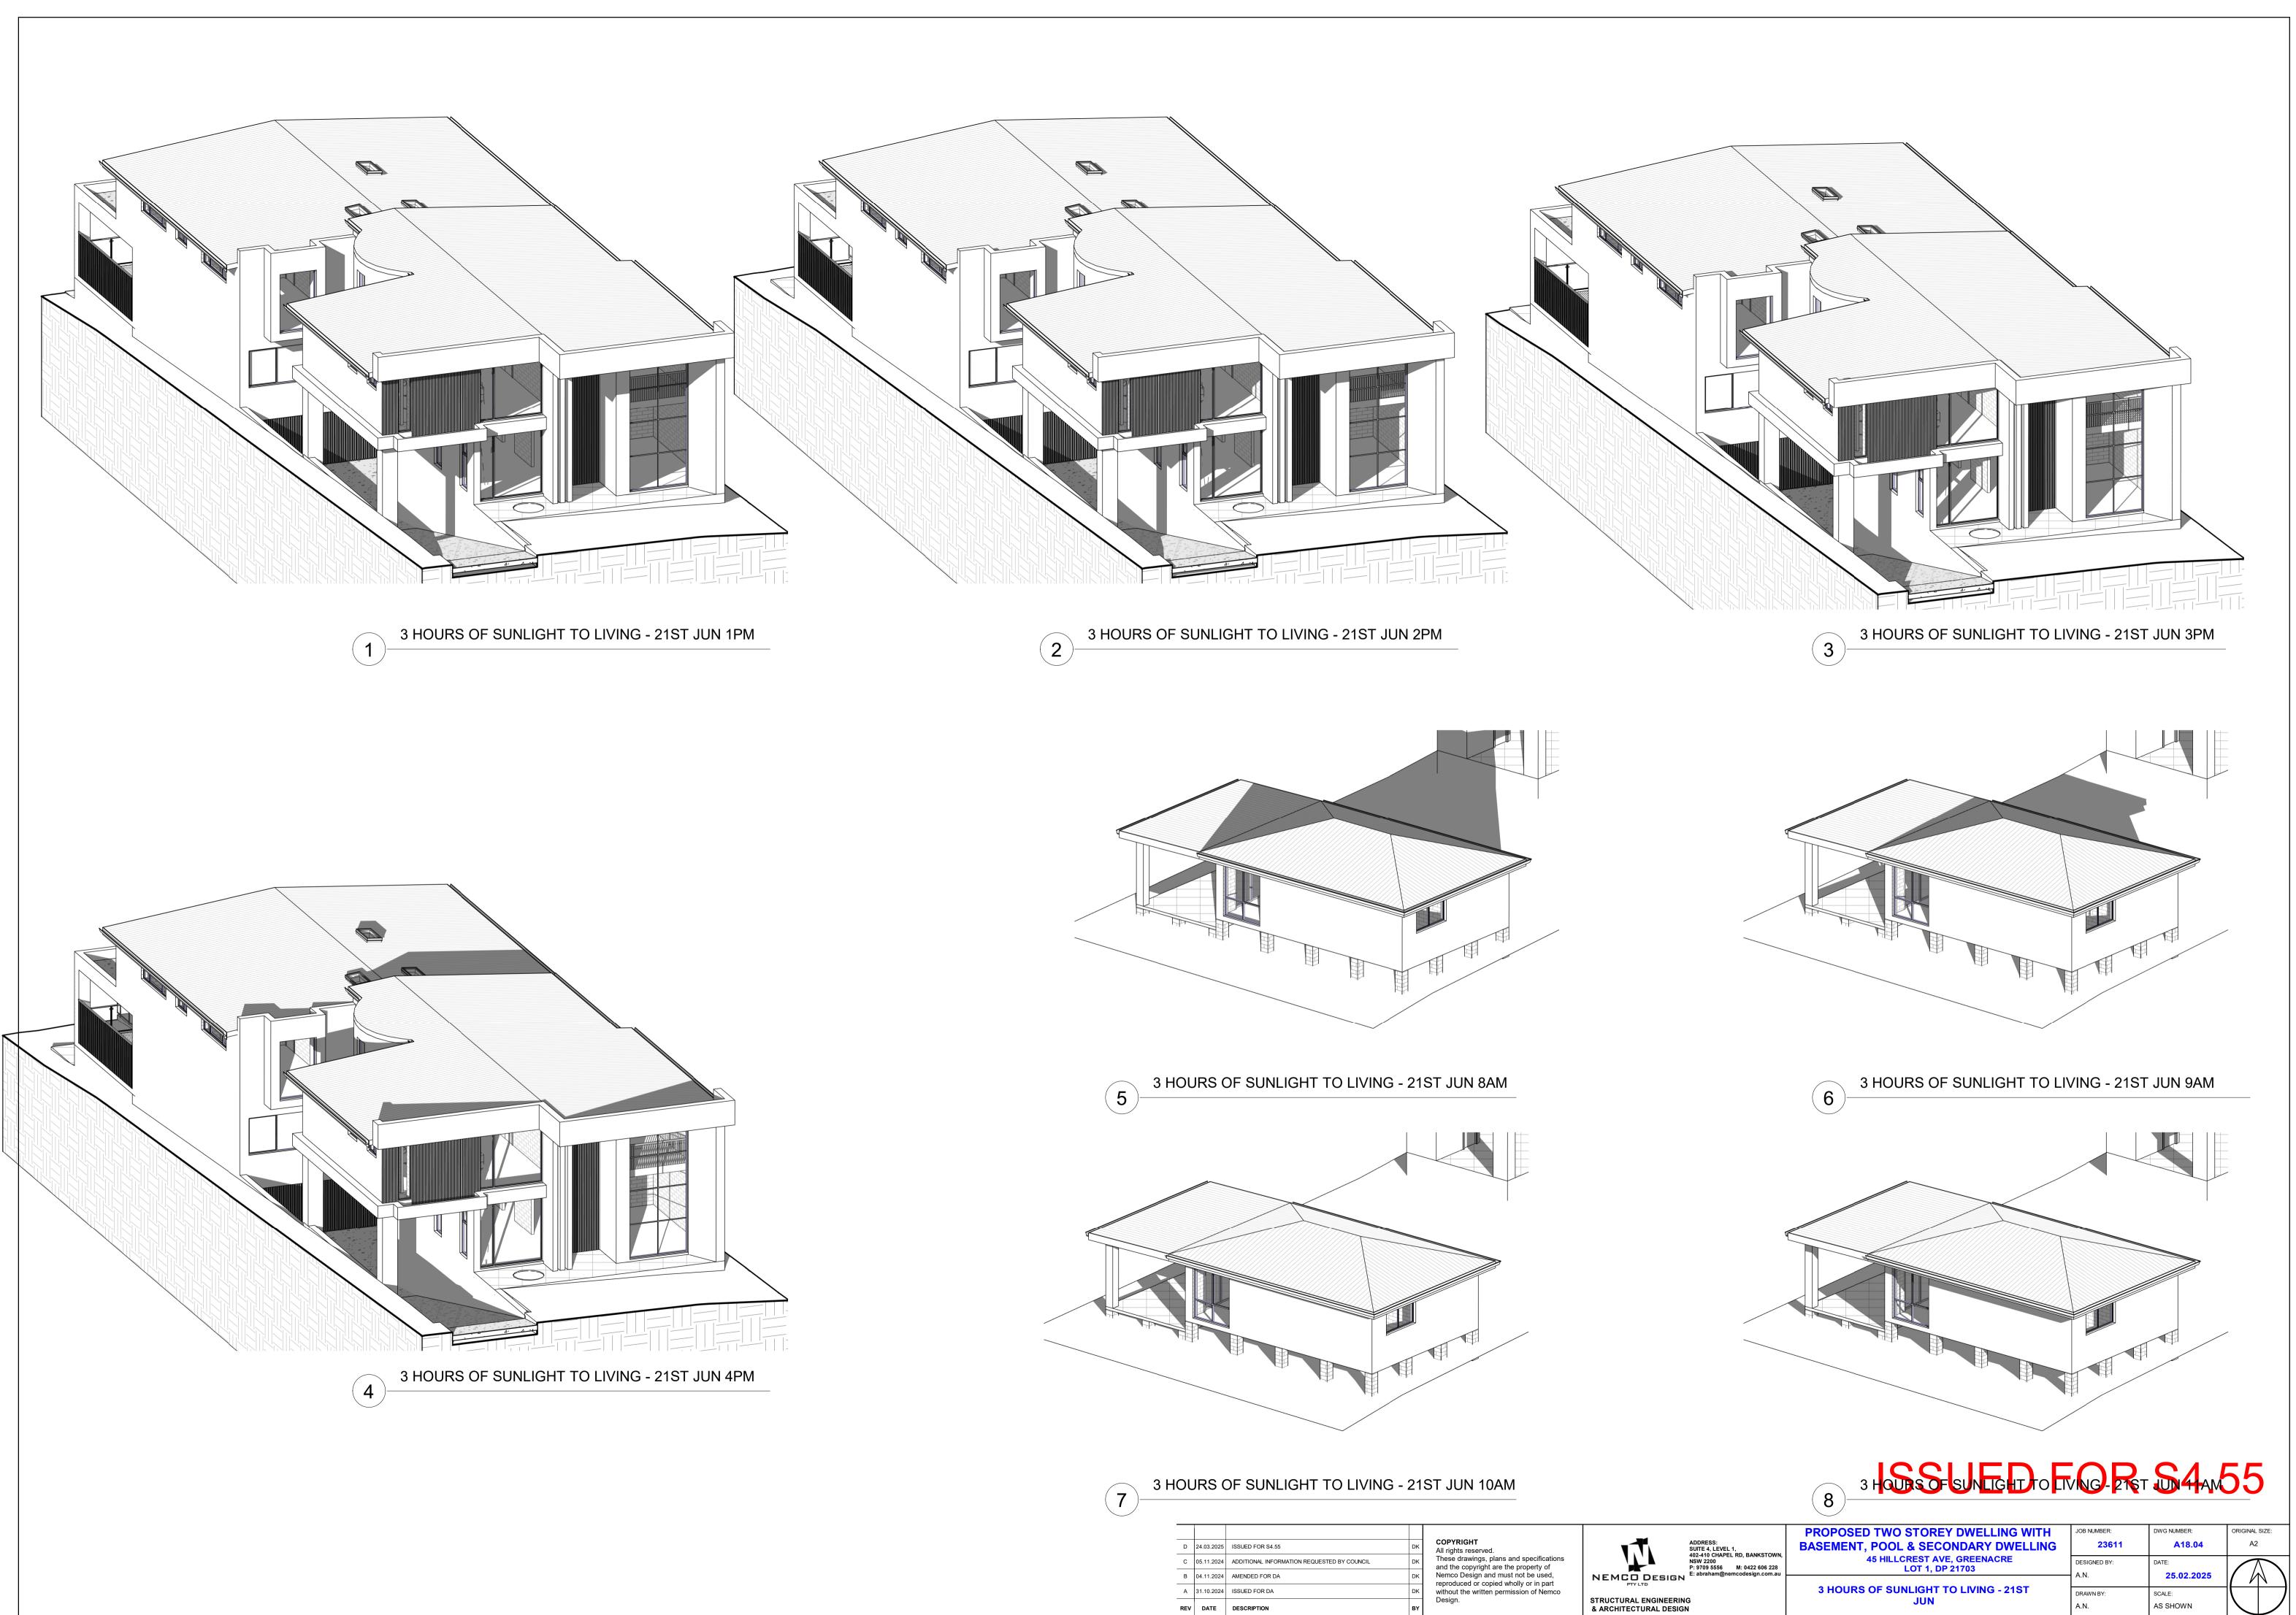


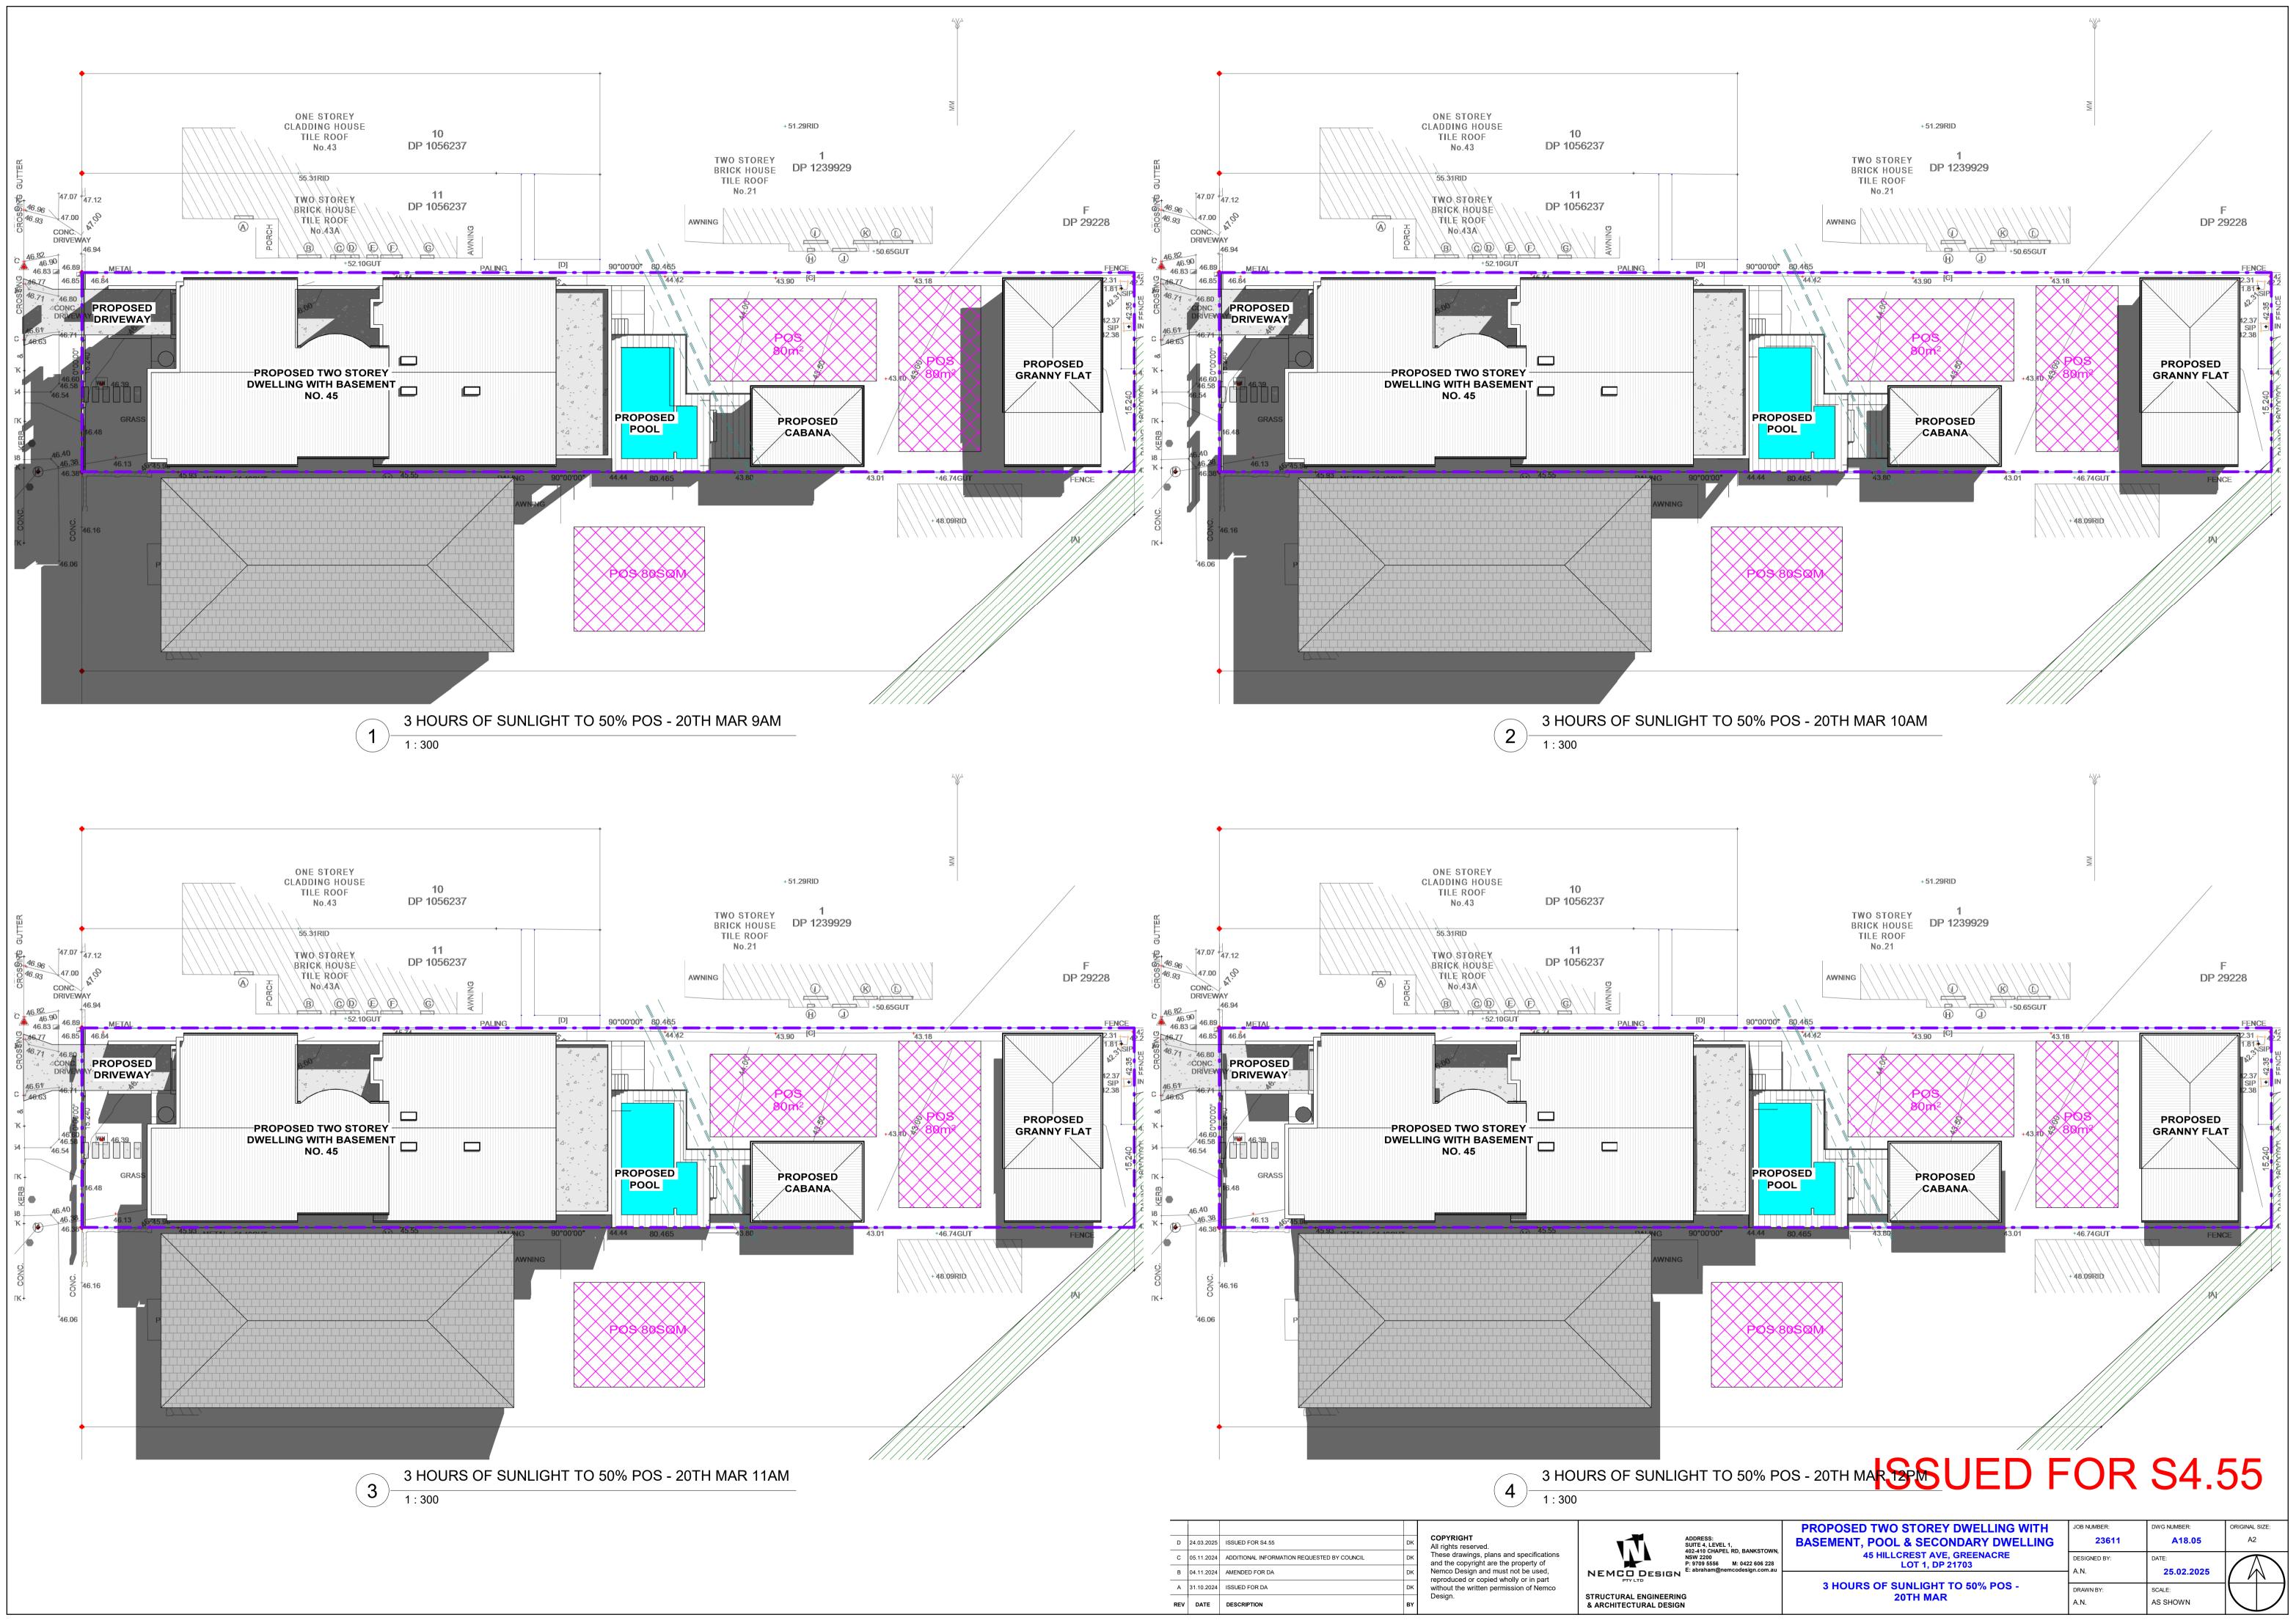
ANKSTOWN.	PROPOSED TWO STOREY DWELLING WITH	JOB NUMBER:	DWG NUMBER:	ORIGINAL SIZE:
	BASEMENT, POOL & SECONDARY DWELLING	23611	A18.02	A2
422 606 228	45 HILLCREST AVE, GREENACRE	DESIGNED BY:	DATE:	
sign.com.au	LOT 1, DP 21703	A.N.	25.02.2025	
	SHADOW DIAGRAM - 21ST JUN	DRAWN BY: A.N.	SCALE: AS SHOWN	



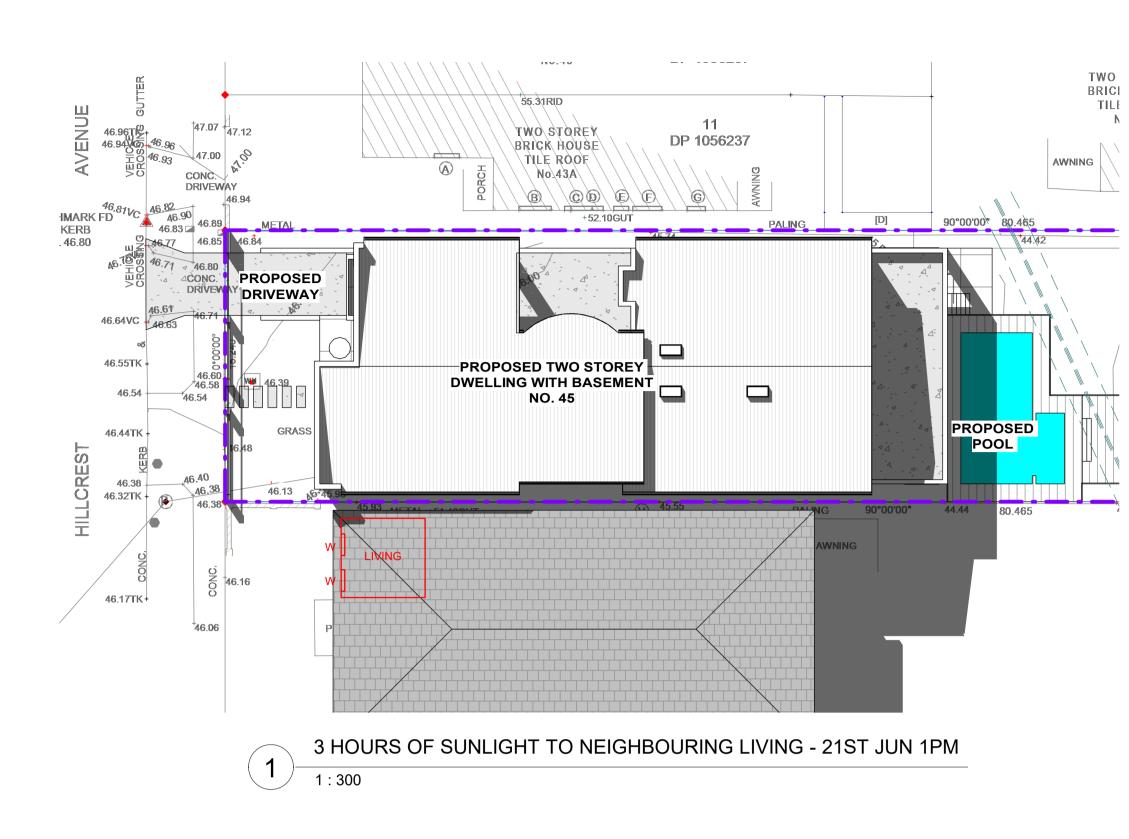
1	SHADOW DIAGRAM - 21ST JUN 2PM 1 : 300
1)-	1 : 300

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	PROPOSED TWO STOREY DWELLING WITH	JOB NUMBER:	DWG NUMBER:	ORIGINAL SIZE:	
	BASEMENT, POOL & SECONDARY DWELLING	23611	A18.03	A2	
BANKSTOWN, 422 606 228 esign.com.au	45 HILLCREST AVE, GREENACRE LOT 1, DP 21703	DESIGNED BY:	DATE:		
oo.goouu		A.N.	25.02.2025		
	SHADOW DIAGRAM - 21ST JUN	DRAWN BY:	SCALE:		
		A.N.	AS SHOWN		

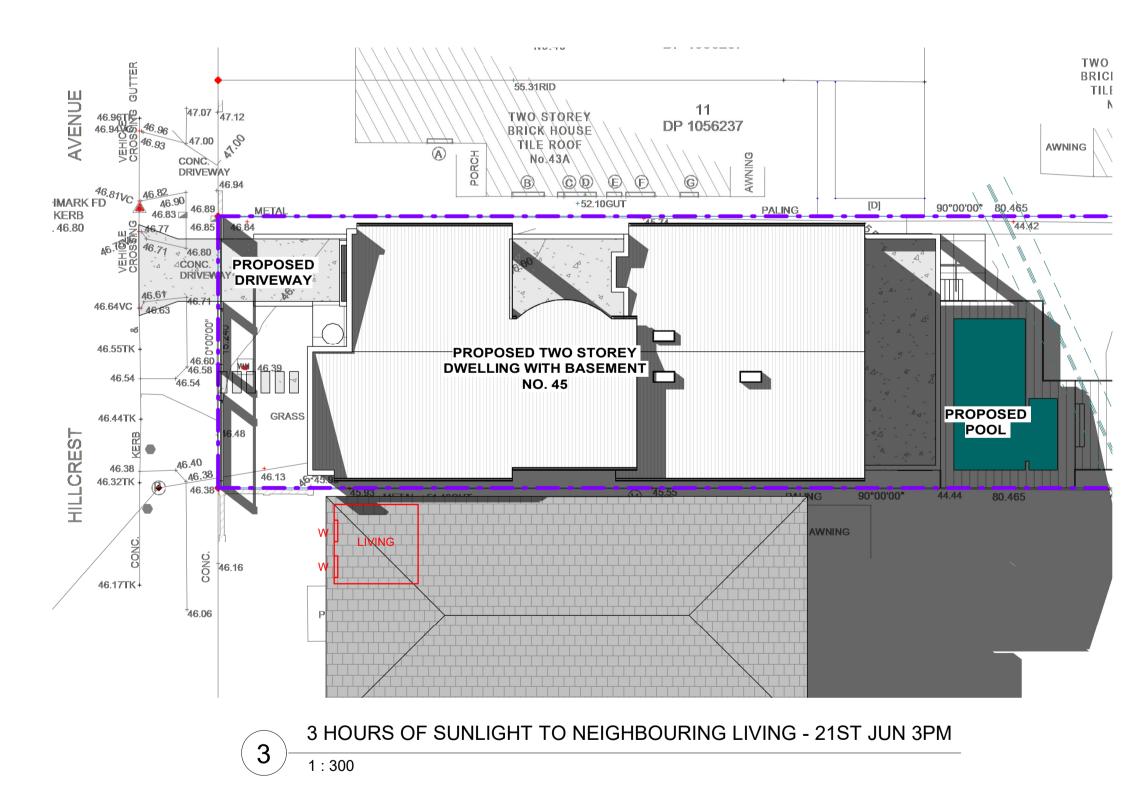


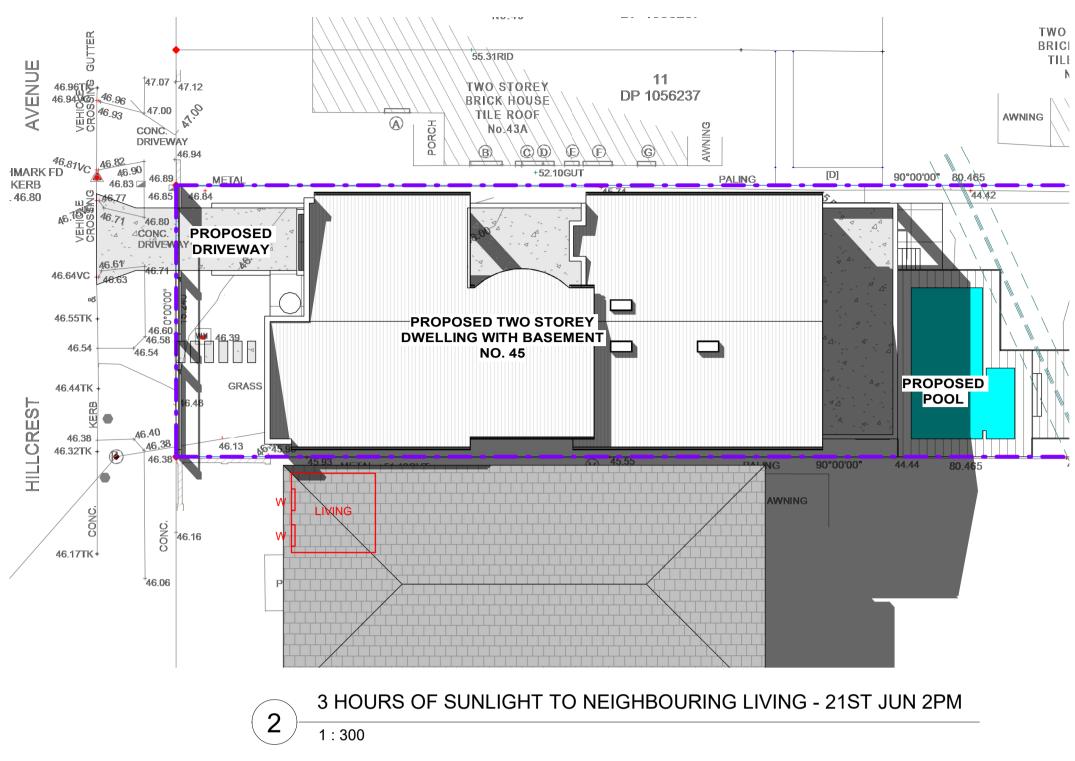


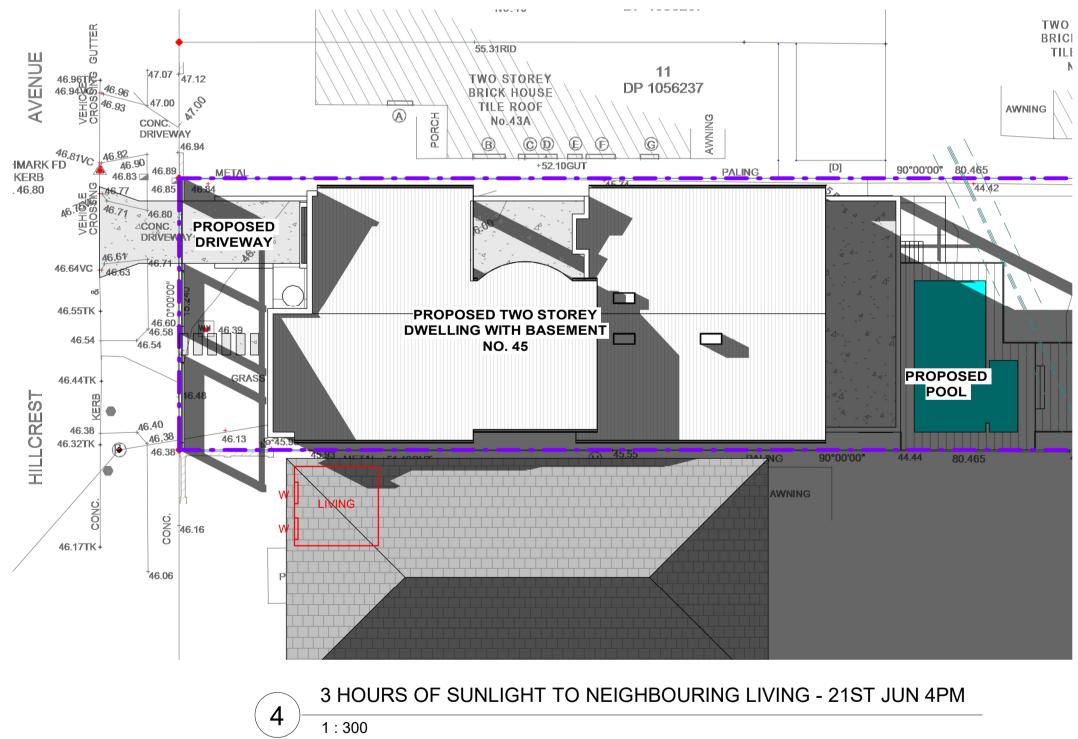
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EVEL 1,	PROPOSED TWO STOREY DWELLING WITH	JOB NUMBER:	DWG NUMBER:	ORIGINAL SIZE:
APEL RD. BANKSTOWN.	BASEMENT, POOL & SECONDARY DWELLING	23611	A18.06	A2
66 M: 0422 606 228	45 HILLCREST AVE, GREENACRE	DESIGNED BY:	DATE:	
@nemcodesign.com.au	LOT 1, DP 21703	A.N.	25.02.2025	
	3 HOURS OF SUNLIGHT TO NEIGHBOURING LIVING - 21ST JUN	DRAWN BY: A.N.	SCALE: AS SHOWN	